



## LICENSE AGREEMENT

This LICENSE AGREEMENT (“License”) is entered into by and between SprintCom, Inc., a Kansas corporation (“Licensee”) and the City of League City (“City”), a municipal corporation, on the date set forth below.

### **Terms:**

#### **1. Definitions:** In this License:

- 1.1. *Antenna Facility* means a communications facility consisting of antennae and associated cabling located on the Licensed Premises
- 1.2. *Authorized Personnel* means employees, engineers, technicians or agents of Licensee (or persons or entities under direct supervision thereof) who either: (1) carry an identification badge identifying them as employees or agents of Licensee; or (2) are employees, engineers or technicians acting on Licensee behalf.
- 1.3. *City* means the City of League City, a municipal corporation.
- 1.4. *Commencement Date* means April 15, 2019.
- 1.5. *Effective Date* (of this License) means the date that this License is fully executed.
- 1.6. *License* means this License Agreement.
- 1.7. *Licensee* means SprintCom, Inc., a Kansas corporation.
- 1.8. *Licensed Premises* means the land consisting of approximately 384 square feet upon which Licensee will maintain its equipment base station (the “Ground Space”) and antenna structure and as further described in Exhibit A (the “Pod”), attached and incorporated to this License by reference, together with any utility easement and the space on the Water Tower being licensed to Licensee by the City.
- 1.9. *Water Tower* means the City’s potable water storage tank located on the Licensed Premises.

#### **2. Grant of License by the City:**

- 2.1. The License Premises, as indicated in Exhibit A, are hereby licensed to Licensee as a site for Licensee to erect, construct, operate, maintain, repair, and replace the Antenna Facility.
- 2.2. Licensee will comply with any reasonable rules and regulations relate to the City’s compliance with Federal Aviation Administration (FAA) Laws and regulations.

- 2.3. If Licensee places any item on the Licensed Premises that is not authorized under this License and does not remove such item after 30 days written notice to Licensee, then the City may remove the item without liability to Licensee for damage caused by the City's removal.
- 2.4. Licensee and its Authorized Personnel may access the Licensed Premises for maintenance, repair, replacement, and removal of the Antenna Facility at any time, subject to the following:
  - 2.4.1. The City's reasonable security requirements;
  - 2.4.2. Licensee will conduct its normal maintenance activities on the Licensed Premises during the City's normal business hours;
  - 2.4.3. Licensee will use its reasonable efforts to contact the City no less than two (2) hours prior to accessing the Licensed Premises;
  - 2.4.4. In case of emergency or unscheduled repairs, Licensee requires access outside of the City's normal business hours, Licensee will provide the City with reasonable notice under the circumstances (at least 1 hour in advance of visit, if possible), Licensee will pay the City the reasonable costs it incurs in providing such access; and
  - 2.4.5. Licensee will furnish the City with a key or the combination or any lock securing the site of Licensee's equipment, so the City may inspect Licensee's equipment at any time; provided, however, that in no event will the City, its employees, officers, or agents remove, relocate, modify, alter or otherwise tamper with Licensee's equipment.
- 2.5. All facilities Licensee provides and installs on the Licensed Premises remain the property of the Licensee and Licensee may remove the same at any time during or within 90 days after the termination of this License (the "Removal Period"). Licensee will continue to pay the City license fees until Licensee removes its property from the Licensed Premises after the Removal Period.
- 2.6. Licensee will abide by all federal, state and local rules and regulations in the operation of the Antenna Facility, including acquiring required licenses and permits.
- 2.7. The City's grant to Licensee is a non-exclusive license. The City may use the Licensed Premises or allow any other person to use such area for any purpose that does not interfere with Licensee's rights granted under this License, except the Ground Space and the exterior space on the Pod, for both of which Licensee is conveyed exclusive use by Lessor.
- 2.8. Licensee may erect and operate the Antennae Facility on the Licensed Premises. Prior to the installation and/or Material Alteration (as defined below) of the Antenna Facility, Licensee will submit plans to the City ("Licensee's Plans") for the City's prior written approval, which approval will not be unreasonably withheld, conditioned or delayed. The City will have ten (10) days following receipt of Licensee's Plans to review the same and to provide written notice to Licensee of the approval or disapproval of the same. If Licensee's Plans are not approved, the disapproval must be accompanied by specific written reasons from the City for disapproval. If the City does not notify Licensee within that ten (10) day period that Licensee's Plans have been disapproved, then Licensee's Plans will be conclusively deemed approved in all respects by the City. If the City timely objects to or disapproves of Licensee's Plans, then Licensee may resubmit Licensee's Plans which the City must approve or disapprove in writing within five (5) days following the City's receipt. If the City fails to timely respond after receipt of the amended Licensee's Plans, then Licensee's Plans will be conclusively deemed approved. The City will not be entitled to any type of administrative fees for its review or approval of such Material Alteration. For purposes of this License, a "Material

"Modification" is anything NOT within the following actions: maintenance, repairs, like-kind, like for less, or similar replacements or upgrades of the Antenna Facility and modifications made within the interior of any shelters, base station equipment or leased entitlements. The City consent or approval is not required for any modifications that are not Material Modifications. If Licensee seeks to increase the number of antennae beyond the number authorized herein, it must first pay for an evaluation to be carried out by a qualified professional demonstrating that (i) each additional antenna will not interfere with the existing antennas and that (ii) the City's Water Tower can structurally support the additional antennas. The cost of the evaluations required by this section must be paid by Licensee within thirty (30) days after receiving written notice of the costs. The parties acknowledge and agree that pursuant to the Previous Agreement (as defined in Section 35 hereof), the initial installation of the Antenna Facility has already occurred and thus the City's prior consent is not needed.

- 2.9. Licensee shall be required to obtain the City's prior written approval for all Material Modification to the Licensed Premises, which approval will not be unreasonably withheld, conditioned or delayed. All modifications or improvements to the Licensed Premises for Licensee's benefit shall be at Licensee's expense and such modifications or improvements shall be maintained in a good state of repair. Licensee's Antenna Facility shall, at all times, be painted, at Licensee's expense, the same color as the Water Tower.
- 2.10. If Licensee interferes with the City's use of the Water Tower, Licensee agrees to cease all such actions that interfere with the City's use thereof no later than five (5) days after receiving written notice of the interference from the City; provided, however, Licensee may conduct intermittent testing of Antenna Facility in order to resolve such interference.
- 2.11. Upon the City's written request, Licensee shall remove or relocate all or part of the Antenna Facility from the License Premises as may be reasonably necessary for the City to repair, rehabilitate, replace, relocate, or maintain the Water Tower. Notwithstanding anything to the contrary contained herein, the parties agree and acknowledge that, due to cost considerations, Licensee will not be required to remove all or part of the Antenna Facility if it can reasonably screen or partially shut down on a temporary basis its Antenna Facility (in whole or in part) while the City repairs, rehabilitates or maintains all or part of the Water Tower. The parties will reasonably coordinate (and cause its contractors to do the same) with each other in order to facilitate same. The City will schedule regular, non-emergency maintenance, repair, or repainting as far in advance as is reasonably possible and give Licensee at least 180 days advance written notice prior to the maintenance, repair, or repainting to allow Licensee to temporarily remove or relocate one or more of its antennae and equipment. The City will use reasonable efforts to enable Licensee to install and operate a temporary site on the License Premises which is suitable as a temporary site for Licensee until the antenna(e) and equipment affected by the temporary relocation can be reinstalled at the original location. The City will cause all work on the Water Tower that requires Licensee to remove or move all or part of its Antenna Facility to be completed in a reasonably prompt manner in order to minimize to the extent reasonably possible the time during which Licensee's Antenna Facility is not located and operating on the Water Tower. In the case of emergency repairs by the City, the City shall provide Licensee with as much notice as possible so that Licensee will remove its equipment at Licensee's own expense so that the emergency repairs may be completed.
- 2.12. If the City removes the Water Tower, the City will schedule the removal as far in advance as possible and give Licensee at least 180 days advance written notice to remove its antennae and equipment. The City will use reasonable efforts to allow Licensee to relocate the antennae and equipment to other City property under a new license, with the same terms and conditions as set forth herein, if the parties agree the new location is a suitable site. Upon Licensee's removal of its antennae and equipment from the Water Tower being removed, this License will terminate.

- 2.13. Licensee shall provide mounting details for the antennae array, cabling, and all appurtenances and equipment to be attached to the Licensed Premises. Such mounting details shall be subject to the reasonable approval of the City.
- 2.14. Licensee shall provide the City with an inspection report certifying the structural integrity of the antenna and appurtenances as mounted and noting any deficiencies of the Water Tower's structural integrity or paint system related to the antenna, cabling or, appurtenances mounted on the Water Tower after the two-year anniversary of the Commencement Date and i) every five years thereafter in the event no Material Modifications have been performed on the Water Tower since the last such inspection and ii) every two years otherwise.
- 2.15. The City agrees that future maintenance contracts with the City for painting the Water Tower shall include a bid item for work-around on the antennae, cabling and appurtenances mounted on the Water Tower according to the specifications Licensee shall supply. Licensee shall reimburse the City for the portion of the Water Tower maintenance project costs attributable to the antennae, cabling, and appurtenances mounted on the Water Tower. Alternatively, Licensee may, at its sole option, remove its equipment during the maintenance project and reinstall it after project completion.
3. **License Term:** The term of this License shall be for five (5) years commencing on the Commencement Date. This License will automatically renew for two (2) successive five (5) year terms as long as Licensee remains in full compliance with all provisions of this License unless (a) Licensee gives the City written notice of its intent not to renew at least thirty (30) days prior to the commencement of the next renewal term, or (b) this License is terminated in accordance with the terms of this License.
4. **License Fee:**
- 4.1. Licensee will pay the City a monthly license fee of **Two Thousand Six Hundred and 00/100 Dollars (\$2,600.00)** for the use of the Licensed Premises, which will be due on the 15<sup>th</sup> of each month in advance. The monthly license fee will automatically increase by three percent (3%), effective on each anniversary date of the Commencement Date.
- 4.2. Licensee will send or tender all license fee payments to the City at the City's address specified in this License or to any other place as the City may designate upon advance written notice to Licensee at least 30 days prior to the date that the next monthly licensee fees is due.
- 4.3. After termination of the License and expiration of the Removal Period (and provided Licensee does not continue to operate the Licensed Premises (which is governed by Section 4.4 hereof)), Licensee will continue to pay to the City a license fee until all of Licensee's personal property is removed and the Water Tower returned to the condition as existing as of the Commencement Date. The above level and quality of restoration shall be confirmed by third party tank inspection selected by City at the expense of Licensee. Normal wear and tear and damage as a result of casualty is excepted.
- 4.4. If Licensee continues to operate the Licensed Premises after the expiration of the term, the license fee shall be adjusted to equal to one hundred twenty-five percent (125%) of the previous license fee amount
5. **Utilities:** Licensee will, at its own expense, contract with a third-party provider for any electric, telephone, telecommunications, or similar utility services, and will be responsible for the installation of any meters or associated equipment needed to serve its Antenna Facility on the Licensed Premises. Licensee will obtain the City's prior approval in writing of the location of any meters, lines, or associated electrical or utility equipment to be located on the Licensed Premises that is not shown on Exhibit A. By

approving the location of any third-party meters, lines or associated equipment, the City grants an easement, at no additional cost to Licensee across the Licensed Premises for that purpose.

6. **Insurance:** Licensee shall maintain Comprehensive General Liability insurance coverage of \$1,000,000 per occurrence throughout the entire term of this License. Licensee shall also maintain the following insurance: (i) Worker's Compensation coverage with statutory limits for the State of Texas, including Employers Liability coverage of \$500,000 per accident; (ii) Automobile Liability coverage of \$1,000,000 Combined Single Limit. In the event the City also maintains insurance, all policies of both parties must contain a waiver of subrogation against the other party. Comprehensive General Liability and Automobile Liability policies must include the City as Additional Insured. Licensee shall provide City Certificates of Insurance evidencing these insurance requirements prior to the start of work.

7. **Termination without Default:**

- 7.1. Licensee may terminate this License for any reason at any time by giving sixty (60) days written notice to the City.
- 7.2. The City may terminate this License at any time by giving Licensee at least 180 days prior written notice of termination, if the City decides to abandon, remove, relocate, or discontinue use the Water Tower, or replaces the Water Tower with another Water Tower. If the existing Water Tower is destroyed by fire, tornado, hurricane, flood, wind, or other natural causes, and the City decides not to replace the Water Tower, this License will terminate on the date of the destruction and the City may retain any license fees paid prior to the date of destruction. If the City chooses to replace the Water Tower, the City will notify Licensee of the estimated date of replacement. If Licensee does not terminate this License by giving notice to the City prior to the date the Water Tower is replaced, this License will remain in effect, but the next License Fee payments will be abated to account for the time the Water Tower was not available for use by Licensee.
- 7.3. Any provision of this License that imposes an obligation upon Licensee that extends beyond the termination of this License, survives the termination of this License.

8. **Termination for Default**

- 8.1. Either party may terminate this License as provided for in this section if the other party fails to comply with a provision of this License. The party claiming a default by the other party will give written notice specifying the default and what must be done to correct the default. If the party receiving the notice fails to correct the default within 30 days of receiving the notice of default, the other party may terminate this License by providing notice of termination to the other party.
  - 8.2. If a claimed default cannot be reasonably cured within 30 days, the other party will not be deemed to be in default if the other party promptly attempts to cure the default upon receiving notice and thereafter cures the default within 120 days from receipt of the notice.
  - 8.3. Notwithstanding anything to the contrary in this License, Licensee's cure period for any monetary default will be 30 days after its receipt of written notice of such default from the City.
9. **Relationship to the City:** Licensee is an independent contractor and is not an employee, partner, joint venture, or agent of the City. Licensee shall be responsible for all expenses necessary to carry out the services under this License and shall not be reimbursed by the City for such expenses except as otherwise provided in this License.

- 10. Notices:** All notices pertaining to this License are considered as delivered when mailed to the following address, either (a) registered, certified or regular mail or (b) overnight reputable national courier (e.g., FedEx, UPS, etc.). Either party may from time to time designate a different address by written notice to the other party.

City:	City of League City 300 West Walker Street League City, Texas 77573 Attn: Director of Public Works
Licensee:	Sprint Property Services Site ID: HO58XC335 Mailstop KSOPHT0101-Z2650 6391 Sprint PCS Parkway Overland Park, Kansas 66251-2650
Mandatory Copy To:	Sprint Law Department Sprint Site ID: HO58XC335 Attn.: Real Estate Attorney Mailstop: KSOPHT0101-Z2020 6391 Sprint Parkway Overland Park, Kansas 66251-2020

- 11. Warranties and Representations:** Licensee warrants and agrees that Licensee shall perform its obligations and conduct all operations in conformity with all applicable federal, state, and local laws, rules, regulations, and ordinances. For any obligation performed on premises owned or controlled by the City, Licensee warrants and agrees that Licensee will perform the obligations hereunder in compliance with all City rules (of which Licensee has been provided written notice), including but not limited to, prohibitions related to tobacco use, alcohol, and other drugs.
- 12. Licenses/Certifications:** Licensee represents and warrants that it will obtain and maintain in effect, and pay the cost of all licenses, permits or certifications that may be necessary for Licensee's performance of the obligations under this License. If Licensee is a business entity, Licensee warrants, represents, covenants, and agrees that it is duly organized, validly existing and in good standing under the laws of the state of its incorporation; and is duly authorized and in good standing to conduct business in the State of Texas, that it has all necessary power and has received all necessary approvals to execute and deliver this License and is authorized to execute this License according to its terms on behalf of Licensee.
- 13. Performance/Qualifications:** Licensee agrees and represents that Licensee has the personnel, experience, and knowledge necessary to qualify Licensee for the particular duties to be performed under this License. Licensee warrants that all services performed under this License shall be performed consistent with generally prevailing professional or industry standards.
- 14. Conflict of Interest:** Licensee warrants, represents, and agrees that Licensee presently has no interest and shall not acquire any interest, direct or indirect, that would conflict in any manner or degree with Licensee's performance of its obligations hereunder. Licensee further warrants and affirms that no relationship or affiliation exists between Licensee and the City that could be construed as a conflict of interest with regard to this License.

- 15. INDEMNIFICATION:** EXCEPT WITH RESPECT TO ANY CLAIMS (AS DEFINED BELOW) ARISING FROM THE NEGLIGENCE OR INTENTIONAL MISCONDUCT OF THE INDEMNIFIED PARTY, ITS EMPLOYEES, AGENTS OR CONTRACTORS, LICENSEE SHALL DEFEND, INDEMNIFY AND HOLD HARMLESS THE CITY , AND EACH OF ITS DIRECTORS, OFFICERS, AGENTS AND EMPLOYEES FROM AND AGAINST ALL CLAIMS, ACTIONS, SUITS, DEMANDS, PROCEEDINGS, COSTS, DAMAGES AND LIABILITIES, INCLUDING WITHOUT LIMITATION ATTORNEYS' FEES AND REASONABLE LITIGATION COSTS ("CLAIMS"), ARISING OUT OF, CONNECTED WITH, OR RESULTING FROM ANY ACTS OR OMISSIONS OF LICENSEE OR ANY AGENT, EMPLOYEE, SUBLICENSEE, OR SUPPLIER OF LICENSEE IN THE EXECUTION OR PERFORMANCE OF THIS CONTRACT, TO THE EXTENT THE CLAIM ARISES FROM NEGLIGENCE, WILLFUL ACT, BREACH OF CONTRACT OR VIOLATION OF LAW.
- 16. Force Majeure:** Neither the City nor Licensee shall be liable for any delay in the performance of this License, nor for any other breach, nor for any loss or damage arising from uncontrollable forces such as fire, theft, storm, war, or any other force majeure that could not have been reasonably avoided by exercise of due diligence.
- 17. Notices:** Any notice given under this contract by either party to the other may be affected either by personal delivery in writing or by mail, registered or certified postage prepaid with return receipt requested. Mailed notices shall be addressed to the addresses of the parties as they appear in the contract. Notices delivered personally shall be deemed communicated at the time of actual receipt. Mailed notice shall be deemed communicated three (3) days after mailing; notices sent via overnight reputable national courier shall be deemed communicated one (1) day after sending.
- 18. Compliance with Laws:** Licensee will, at its expense, conduct all operations on the Licensed Premises in compliance with all laws, ordinances, rules, regulations, orders or directives of any government authority, and will not commit or allow to be committed any public or private nuisance thereon.
- 19. State Auditor:** Licensee understands that acceptance of funds under this License constitutes acceptance of the authority of the Texas State Auditor's Office, or any successor agency (collectively, "Auditor"), to conduct an audit or investigation in connection with those funds. Licensee agrees to cooperate with the Auditor in the conduct of the audit or investigation, including without limitation providing all records requested. Licensee will use good faith efforts to include this provision in all contracts with permitted subcontractors.
- 20. Jurisdiction:** Any disputes under this License shall be brought in a court of competent jurisdiction in Galveston, Texas and governed by Texas law.
- 21. Alternative Dispute Resolution:** To the extent that Chapter 2260, Texas Government Code, is applicable to this Contract and is not preempted by other applicable law, the dispute resolution process provided for in Chapter 2260 and the related rules adopted by the Texas Attorney General Pursuant to Chapter 2260, shall be used by the City and the Licensee to attempt to resolve any claim for breach of contract made by Licensee that cannot be resolved in the ordinary course of business. The Director of Finance of the City shall examine Licensee's claim and any counterclaim and negotiate with Licensee in an effort to resolve such claims. The parties hereto specifically agree that (i) neither the occurrence of an

event giving rise to a breach of contract claim nor the pendency of a claim constitute grounds for the suspension of performance by Licensee, (ii) neither the issuance of this Contract by the City nor any other conduct, action or inaction of any representative of the City relating to this contract constitutes or is intended to constitute a waiver of the City's or the state's sovereign immunity to suit; and (iii) the City has not waived its right to seek redress in the courts.

22. **[Reserved]:**
23. **Risk of Loss:** If applicable, all work performed by Licensee pursuant to this License will be at Licensee's exclusive risk until final and complete acceptance of the work by City. In the case of any loss or damage to the work prior to City's acceptance, such loss or damage will be Licensee's responsibility.
24. **Publicity:** Neither party shall use the other's name, logo or likeness in any press release, marketing materials or other public announcement without receiving the other party's prior written approval.
25. **Legal Construction/Severability:** In the event that any one or more of the provisions contained in this License shall for any reason be held to be invalid, illegal or unenforceable in any respect, such invalidity, illegality or unenforceability shall not affect any other provision, and this License shall be construed as if such invalid, illegal or unenforceable provisions had never been contained in it. To this end, the provisions of this License are declared to be severable. The parties may mutually agree to renegotiate this License to cure such illegality/invalidity or unconstitutionality if such may be reasonably accomplished.
26. **Limitations:** The Parties are aware that there are constitutional and statutory limitations on the authority of City to enter into certain terms and conditions of this License, including, but not limited to, those terms and conditions relating to liens on City's property; disclaimers and limitations of warranties; disclaimers and limitations of liability for damages; waivers, disclaimers and limitations of legal rights, remedies, requirements and processes; limitations of periods to bring legal action; granting control of litigation or settlement to another party; liability for acts or omissions of third parties; payment of attorneys' fees; dispute resolution; indemnities; and confidentiality (collectively, the "Limitations"), and terms and conditions related to the Limitations will not be binding on City except to the extent authorized by the laws and Constitution of the State of Texas.
27. **Sovereign Immunity:** Except as otherwise provided by Texas law, neither the execution of this License by City nor any other conduct, action or inaction of any City representative relating to this License is a waiver of sovereign immunity by City.
28. **Authority:** Each party warrants and represents to the other that said party has full power and authority to enter into and perform this License and to make the grant of rights contained herein.
29. **Non-Waiver:** No covenant or condition of this License may be waived except by written consent of the waiving party. Forbearance or indulgence by one party in any regard whatsoever shall not constitute a waiver of the covenant or condition to be performed by the other party.
30. **Assignability:** Licensee may not assign or sublet all or any portion of the Licensed Premises without the prior written consent of the City, which consent will not be unreasonably withheld, conditioned or delayed. Licensee shall have the right to sublease or assign its rights under this License to any of its subsidiaries, affiliates, or successor legal entities, to any entity acquiring substantially all of the assets of Licensee or to any subsidiary or affiliate Licensee without the consent of the City.
31. **Prohibition on Boycotting Israel:** Pursuant to Section 2270.002, Texas Government Code, by executing this License Licensee verifies that Licensee: (1) does not boycott Israel; and (2) will not boycott Israel during the term of this License.

32. **Prohibition Against Business with Iran, Sudan or Foreign Terrorists Organizations:** Licensee warrants, covenants, and represents that Licensee is not engaged in business with Iran, Sudan, or any company identified on the list referenced in Section 2252.152, Texas Government Code.
33. **Hazardous Substances.** City represents that it has no knowledge of any substance, chemical or waste (collectively, substance) on the Licensed Premises that is identified as hazardous, toxic or dangerous in any applicable federal, state or local law or regulation. Licensee will not introduce or use any such substance on the Licensed Premises in violation of any applicable law.
34. **Entire Agreement:** This License contains the entire agreement between the parties and supersedes all prior agreements, arrangements, and understanding, oral or written between the parties relating to this License. This License may not be modified except by mutual written agreement of the parties executed subsequent to this License.
35. **Previous Agreement:** The parties acknowledge that the Leased Premises were governed by that certain PCS Site Agreement dated April 2, 2004 by and between the parties (the "Previous Agreement") and that the installation of the Antenna Facility at the Leased Premises was permitted thereunder and, therefore, is currently in compliance with the terms of this License.
36. **Memorandum of Agreement.** The parties shall execute concurrently with this License a recordable Memorandum of Agreement attached to this License as Exhibit B, which Licensee may record at its own expense in the real property records where the Licensed Premises is located.

Executed this \_\_\_\_\_ day of \_\_\_\_\_, 2018. (*date to be filled in by the City Secretary*)


SPRINTCOM, INC. - "Licensee"

 2/25/2019  
Silvia J. Lin, Manager – Real Estate


CITY OF LEAGUE CITY – "City"

John Baumgartner, City Manager

Attest:

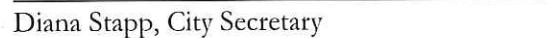  
Diana Stapp, City Secretary

Approved as to Form:

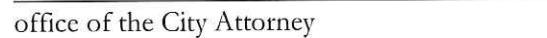  
office of the City Attorney

**EXHIBIT "A"**

**LICENSED PREMISES AND ANTENNA FACILITY**

(SEE ATTACHED)

# Sprint

**PROJECT NAME:**
**CWE-SUBSTANTIAL SERVICES**
**5-15 MHz-MM on Macro**
**LEAGUE CITY COUNTRYSIDE WT**
**SITE NAME:**
**HO58XC335**
**SITE NUMBER:**
**STRUCTURE TYPE:**
**WATER TANK**
**MARKET:**
**HOUSTON**
**JURISDICTION:**
**CITY OF LEAGUE CITY**


PROJECT SUMMARY		DRIVING DIRECTIONS	VICINITY MAP	LIST OF DRAWINGS								
SITE NAME: SITE NUMBER: SITE ADDRESS: LATITUDE: LONGITUDE: GROUND ELEVATION:	LEAGUE CITY COUNTRYSIDE WT HO58XC335 5123 1/2 CANDLEWOOD LEAGUE CITY, TX 77573 29°48'27"S -95.142344" 28' ANSI	DEPART 77061 ON WILLIAM P. HOBBY AIRPORT, HOUSTON, TX. HEAD EAST, ON HOBBY AIRPORT LOOP, 0.2 MI. KEEP LEFT TO STAY ON HOBBY AIRPORT LOOP. 0.1 MI. TURN RIGHT ON HOBBY AIRPORT, AND TURN LEFT ON HOBBY AIRPORT, AND TURN LEFT ON HOBBY AIRPORT. 0.6 MI. USE THE LEFT LANE TO TAKE THE GULF Fwy. 0.6 MI. USE THE LEFT LANE TO TAKE THE INTERSTATE 45 S. SLIP ROAD 0.3 MI. MERGE ONTO I-45 S. 11.2 MI. TAKE EXIT 23 TOWARDS FARM TO MARKET 518 / LEAGUE CITY 0.2 MI. MERGE ONTO GULF Fwy. 1.0 MI. USE THE RIGHT 2 LANES TO TURN RIGHT ONTO W MAIN ST. 1.6 MI. TURN LEFT ONTO SPRING LANDING DR. 0.3 MI. TURN RIGHT ONTO CANYON CREST DR. 0.1 MI. CANYON CREST DR. TURNS LEFT AND BECOMES CEDARFERRY DR. 0.433 FT. TURN LEFT ONTO CEDARFERRY DR. 0.2 MI. TURN LEFT ONTO CANDLEWOOD DR. 0.1 MI. ARRIVE. SAR34006		<b>SITE GENERAL ARRANGEMENT PLANS</b> T-1 TITLE SHEET T-2 GENERAL NOTES <b>ARCHITECTURAL / CIVIL PLANS</b> A-1 OVERALL SITE PLAN A-2 EQUIPMENT PLAN A-3 SITE ELEVATION & ANTELLA LAYOUT A-4 EQUIPMENT DETAILS A-5 EQUIPMENT DETAILS <b>ELECTRICAL PLANS</b> E-1 GROUNDDING & ELECTRICAL PLAN E-2 GROUNDDING DETAILS E-3 DC POWER & DISTRIBUTION E-4 AC POWER & DISTRIBUTION <b>NOTE:</b> DRAWING SCALES ARE FOR 24"X36" SHEETS UNLESS OTHERWISE NOTED.								
<b>SCOPE OF WORK</b>		<p>1) THE WIRELESS COMMUNICATIONS FACILITY IS NOT INTENDED FOR HUMAN OCCUPANCY. IT DOES NOT REQUIRE POTABLE WATER AND WILL NOT PROVIDE ANY SERVICE.</p> <p>2) THE SCOPE OF WORK CONSISTS OF MODIFYING THE EXISTING WIRELESS INSTALLATION:</p> <ul style="list-style-type: none"> <li>A. INSTALL SPRINT ANTENNAS</li> <li>B. INSTALL (3) SPRINT MINI MACRO RADIOS</li> <li>C. INSTALL (3) SLOW POWER CABLE</li> <li>D. (3) * CORRUGATED PVC CONDUIT FOR FIBER &amp; ETHERNET CABLES</li> </ul>										
<b>APPLICABLE CODES &amp; STANDARDS</b>		<p>SPRINT PCS 6391 SPRINT PARKWAY OVERLAND PARK, KANSAS 66251 NOC: 800-400-5040</p> <p>TOWER OWNER: LEAGUE CITY PUBLIC WORKS PHONE: 28-554-1390</p> <p>CONSTRUCTION MANAGER: EDDIE SMITH 1-801-217-1502</p> <p>ARCHITECT/ENGINEER: ARIA SERVICES, INC. 10006 LYNNBROOK DR. HOUSTON, TX 77042 CONTACT: IRSAN TISNABUDI PHONE: 281-791-4387</p> <p>SITE ACCESS PROCEDURES COMPOUND: NO LOCK BITS: 0335</p> <p>TELEPHONE COMPANY: VERIZON</p> <p>POWER COMPANY: T-XU</p> <p>CALL ONE ONE CALL (800) 522-6543 CALL 3 WORKING DAYS BEFORE YOU DIG!</p>										
		<p><b>SPECIAL NOTES</b></p> <table border="1"> <thead> <tr> <th>NO DESCRIPTION</th> <th>REVISION HISTORY</th> </tr> </thead> <tbody> <tr> <td>△ SUBMISSION: SEC CD</td> <td>SB 11/03/16</td> </tr> </tbody> </table> <p>1. ALL WORK SHALL BE INSTALLED IN CONFORMANCE WITH CURRENT SPRINT CONSTRUCTION INSTALLATION GUIDE</p> <p>2. EXISTING CONDITIONS WILL BE CHANGED &amp; VERIFIED IN FIELD. IF SIGNIFICANT DEVIATIONS OR DETERIORATION ARE ENCOUNTERED AT THE TIME OF CONSTRUCTION, A REPAIR PERMIT WILL BE OBTAINED &amp; CONTRACTOR SHALL NOTIFY ENGINEER IMMEDIATELY.</p> <p>3. CONTRACTOR SHALL NOTIFY ALL APPLICABLE LOCAL INSPECTION &amp; REGULATING AUTHORITIES &amp; ENGINEER IN WRITING OF ANY DISCRENCIES &amp; CONDITIONS ON THE JOB SITE &amp; SWIMMING POOL.</p> <p>4. THE WORK OR BE RESPONSIBLE FOR SAME. THESE DRAWINGS ARE FULL SIZE &amp; SCALEABLE ON 22"X34". SHEET SIZE &amp; ARE NOT REDUCED IN SIZE.</p>			NO DESCRIPTION	REVISION HISTORY	△ SUBMISSION: SEC CD	SB 11/03/16				
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		<p><b>APPROVALS</b></p> <table border="1"> <thead> <tr> <th>PROJECT MANAGER</th> <th>DATE</th> </tr> </thead> <tbody> <tr> <td>RF ENGINEERING</td> <td>DATE</td> </tr> <tr> <td>SITE OWNER</td> <td>DATE</td> </tr> <tr> <td>CONSTRUCTION MANAGER</td> <td>DATE</td> </tr> </tbody> </table> <p>ERICSSON THE ABOVE PARTIES HEREBY APPROVE AND ACCEPT THESE DOCUMENTS AND AUTHORIZE CONTRACTOR TO PROCEED WITH THE CONSTRUCTION DESCRIBED HEREIN. ALL DOCUMENTS ARE SUBJECT TO REVIEW BY THE LOCAL BUILDING DEPARTMENT AND MAY IMPOSE CHANGES OR MODIFICATIONS.</p> <p><b>SITE ACCESS PROCEDURES</b></p> <p>MUST CALL WATER DEPARTMENT AT 281-332-2566 OR 281-808-6717 FOR SITE ACCESS.</p>			PROJECT MANAGER	DATE	RF ENGINEERING	DATE	SITE OWNER	DATE	CONSTRUCTION MANAGER	DATE
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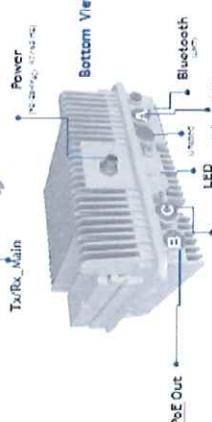
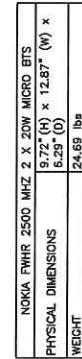
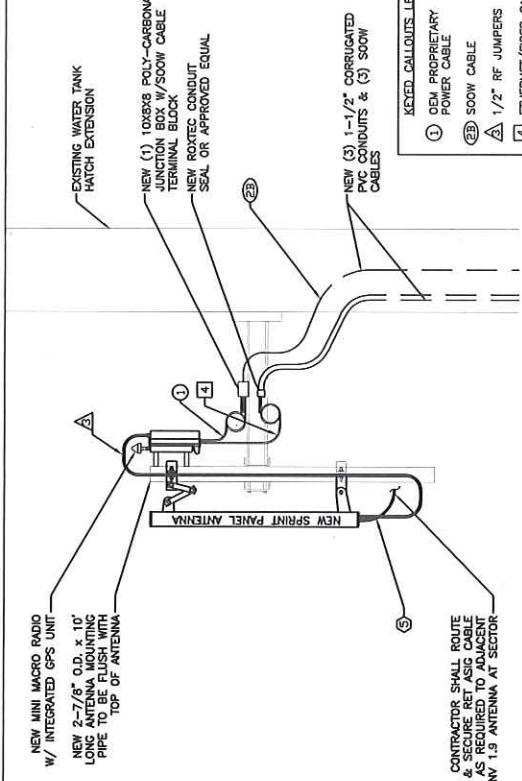
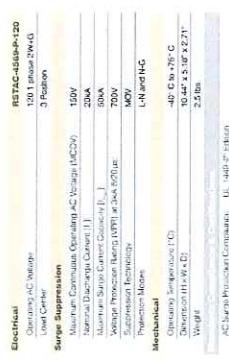


<p><b>WEATHERPROOFING, EXTERIOR CONNECTORS AND FIBER CABLE GROUND KITS.</b></p> <p>A. ALL FIBER &amp; COAX CONNECTORS AND GROUND KITS SHALL BE WEATHERPROOF.</p> <p>B. WEATHERPROOF USING ONE OF THE FOLLOWING METHODS. ALL INSTALLATIONS MUST BE DONE IN ACCORDANCE WITH THE MANUFACTURER'S RECOMMENDATIONS AND INDUSTRY BEST PRACTICES.</p> <ol style="list-style-type: none"> <li>1. NOT APPLICABLE.</li> <li>2. 3M MINI ENCLOSURE OR AMPHENOL JUMPER WITH A BOOT (CONTACT LOCAL SPRINT CM FOR APPROVED ENCLOSURES).</li> <li>3. JMA-WPS SERIES ENCLOSURE.</li> <li>4. NOT APPLICABLE.</li> <li>5. OPEN FLAME ON JOBSITE IS NOT ACCEPTABLE</li> </ol> <p><b>SUMMARY:</b></p> <p>A. THIS SECTION SPECIFIES RBS CABINETS, POWER CABINETS, AND INTERNAL EQUIPMENT INCLUDING BUT NOT LIMITED TO RECTIFIERS, POWER DISTRIBUTION UNITS, BASE BAND UNITS, SURGE ARRESTORS, BATTERIES, AND SIMILAR EQUIPMENT FURNISHED BY THE COMPANY FOR INSTALLATION BY THE CONTRACTOR (OFC).</p> <p>B. CONTRACTOR SHALL PROVIDE AND INSTALL ALL HIGHEST QUALITY MATERIALS AND PROVIDE ALL LABOR REQUIRED FOR INSTALLATION EQUIPMENT IN ENGINEERING, CABINET OR NEW CABINET AS SHOWN ON DRAWINGS AND AS REQUIRE BY THE APPLICABLE INSTALLATION WORKS.</p> <p>C. COMPLY WITH MANUFACTURERS INSTALLATION AND START-UP REQUIREMENTS.</p> <p><b>DC CIRCUIT BREAKER LABELING</b></p> <p>A. LABEL CIRCUIT BREAKERS ACCORDING TO SPRINT CELL SITE ENGINEERING NOTICE – EN 2012-001, REV 1.</p> <p><b>SECTION 26.1.00 – BASIC ELECTRICAL REQUIREMENTS</b></p> <p><b>SUMMARY:</b></p> <p>THIS SECTION SPECIFIES BASIC ELECTRICAL REQUIREMENTS FOR SYSTEMS AND COMPONENTS.</p> <p><b>QUALITY ASSURANCE:</b></p> <p>A. ALL EQUIPMENT FURNISHED UNDER DIVISION 26 SHALL CARRY UL LABELS AND LISTINGS WHERE SUCH LABELS AND LISTINGS ARE AVAILABLE IN THE INDUSTRY.</p> <p>B. MANUFACTURERS OF EQUIPMENT SHALL HAVE A MINIMUM OF THREE YEARS EXPERIENCE WITH THEIR EQUIPMENT INSTALLED AND OPERATING IN THE FIELD IN A USE SIMILAR TO THE PROPOSED USE FOR THIS PROJECT.</p> <p>C. MATERIALS AND EQUIPMENT: ALL MATERIALS AND EQUIPMENT SPECIFIED IN DIVISION 26 OF THE SAME TYPE SHALL BE OF THE SAME MANUFACTURER AND SHALL BE NEW, OF THE BEST QUALITY AND DESIGN, AND FREE FROM DEFECTS.</p> <p><b>SUPPORTING DEVICES:</b></p> <p>A. MANUFACTURED STRUCTURAL SUPPORT MATERIALS: SUBJECT TO COMPLIANCE WITH REQUIREMENTS, PROVIDE PRODUCTS BY THE FOLLOWING:</p> <ol style="list-style-type: none"> <li>1. ALLIED TUBE AND CONDUIT</li> <li>2. B-LINE SYSTEM</li> <li>3. SUNSTRUT DIVERSIFIED PRODUCTS</li> <li>4. THOMAS &amp; BETTS</li> <li>B. FASTENERS: TYPES, MATERIALS, AND CONSTRUCTION FEATURES AS FOLLOWS:</li> </ol> <ol style="list-style-type: none"> <li>1. EXPANSION ANCHORS: CARBON STEEL WEDGE OR SLEEVE TYPE.</li> <li>2. POWER-DRIVEN THREADED STUDS: HEAT-TREATED STEEL, DESIGNED SPECIFICALLY FOR THE INTENDED SERVICE.</li> <li>3. FASTEN BY MEANS OF WOOD SCREWS ON WOOD.</li> <li>4. TOGGLE BOLTS ON HOLLOW MASONRY UNITS.</li> <li>5. CONCRETE INSERTS OR EXPANSION BOLTS ON CONCRETE OR SOLID MASONRY.</li> <li>6. MACHINE SCREWS, WELDED THREADED STUDS, OR SPRING-TENSION CLAMPS ON STEEL.</li> <li>7. EXPLOSIVE DEVICES FOR ATTACHING HANGERS TO STRUCTURE SHALL NOT BE PERMITTED.</li> </ol>	<p>E. DO NOT HOLD CONDUIT, PIPE STRAPS, OR ITEMS OTHER THAN THREADED STUDS TO STEEL STRUCTURES.</p> <p>9. IN PARTITIONS OF LIGHT STEEL CONSTRUCTION, USE SHEET METAL SCREWS.</p> <p><b>SUPPORTING DEVICES:</b></p> <ol style="list-style-type: none"> <li>A. INSTALL SUPPORTING DEVICES TO FASTEN ELECTRICAL COMPONENTS SECURELY AND PERMANENTLY IN ACCORDANCE WITH NEC.</li> <li>B. COORDINATE WITH THE BUILDING STRUCTURAL SYSTEM AND WITH OTHER TRADES.</li> <li>C. UNLESS OTHERWISE INDICATED ON THE DRAWINGS, FASTEN ELECTRICAL ITEMS AND THEIR SUPPORTING HARDWARE SECURELY TO THE STRUCTURE IN ACCORDANCE WITH THE FOLLOWING:</li> <li>D. ENSURE THAT THE LOAD APPLIED BY ANY FASTENER DOES NOT EXCEED 25 PERCENT OF THE PROOF TEST LOAD.</li> <li>E. USE VIBRATION AND SHOCK-RESISTANT FASTENERS FOR ATTACHMENTS TO CONCRETE SLABS.</li> </ol> <p><b>ELECTRICAL IDENTIFICATION:</b></p> <ol style="list-style-type: none"> <li>A. UPDATE AND PROVIDE TYPED CIRCUIT BREAKER SCHEDULES IN THE MOUNTING BRACKET, INSIDE DOORS OF AC PANEL BOARDS WITH ANY CHANGES MADE TO THE AC SYSTEM.</li> <li>B. BRANCH CIRCUITS FEEDING AVIATION OBSTRUCTION LIGHTING EQUIPMENT SHALL BE CLEARLY IDENTIFIED AS SUCH AT THE BRANCH CIRCUIT PANELBOARD.</li> </ol> <p><b>SECTION 26.200 – ELECTRICAL MATERIALS AND EQUIPMENT CONDUIT:</b></p> <p>A. RIGID, OVALIZED STEEL (ROGS) CONDUIT SHALL BE USED FOR EXTERIOR LOCATIONS ABOVE GROUND AND IN UNFINISHED INTERIOR LOCATIONS AND FOR EXPOSED RUNS IN CONCRETE, RIGID CONDUIT AND FITTINGS SHALL BE STEEL COATED WITH ZINC EXTERIOR AND INTERIOR BY THE HOT DIP GALVANIZING PROCESS. CONDUIT SHALL BE PRODUCED TO ANSI SPECIFICATIONS CGO-1, FEDERAL SPECIFICATION VW-C-581 AND SHALL BE LISTED WITH THE UNDERWRITERS LABORATORIES. FITTINGS SHALL BE THREADED – SET SCREW OR COMPRESSION FITTINGS WILL NOT BE ACCEPTABLE. ROG CONDUITS SHALL BE MANUFACTURED BY ALLIED, REPUBLIC OR WHEATLAND.</p> <p>B. UNDERGROUND CONDUIT IN CONCRETE SHALL BE POLYVINYLCHLORIDE (PVC) SUITABLE FOR DIRECT BURIAL AS APPLICABLE. JOINTS SHALL BE BELLIED, AND FLUSH SOLVENT WELDED IN ACCORDANCE WITH MANUFACTURER'S INSTRUCTIONS. CONDUIT SHALL BE CARBON ELECTRICAL PRODUCTS OR APPROVED EQUAL.</p> <p>C. TRANSITIONS BETWEEN PVC AND RIGID (RG) SHALL BE MADE WITH PVC COATED METALLIC LONG SWEEP RADIOS ELBOWS.</p> <p>D. ALL UNDERGROUND CONDUIT OR CONDUIT IN CONCRETE SHOULD BE PVC, EXIT OR RIGID GALVANIZED STEEL CONDUIT MAY BE USED IN FINISHED SPACES CONCEALED IN WALLS AND CEILINGS. EXIT SHALL BE MILD STEEL, ELECTRICALLY WELDED, AND PRODUCED TO ANSI STC-001, LISTED. EXTERIOR CONDUIT SHALL BE HOT DIP GALVANIZED AND SHALL BE MANUFACTURED BY ALLIED, REPUBLIC, OR WHEATLAND. IF ROG CONDUIT IS USED, THE EQUAL FITTINGS SHALL BE METALLIC COMPRESSION, SET SCREW CONNECTIONS SHALL NOT BE ACCEPTABLE.</p> <p>E. LIQUID TIGHT FLEXIBLE METALLIC CONDUIT SHALL BE USED FOR FINAL CONNECTION TO EQUIPMENT. FITTINGS SHALL BE METALLIC GLAND TYPE COMPRESSION FITTINGS, MAINTAINING THE INTEGRITY OF CONDUIT SYSTEM. SET SCREW CONNECTIONS SHALL NOT BE ACCEPTABLE. MAXIMUM LENGTH OF FLEXIBLE CONDUIT SHALL NOT EXCEED 10' (3.05m). IF ROG CONDUIT IS USED, THE EQUAL FITTINGS SHALL BE MANUFACTURED BY ALLIED, REPUBLIC, OR WHEATLAND. IF ROG CONDUIT IS USED, THE EQUAL FITTINGS SHALL BE METALLIC COMPRESSION, SET SCREW CONNECTIONS SHALL NOT BE ACCEPTABLE.</p> <p>F. MINIMUM SIZE CONDUIT SHALL BE USED FOR FINAL CONNECTION HUBS AND BOXES:</p> <p>A. AT ENTRANCES TO CABINETS OR OTHER EQUIPMENT NOT HAVING INTEGRAL THREADED HUBS PROVIDE METALLIC THREADED HUBS OF THE SIZE AND CONFIGURATION REQUIRED. HUB SHALL INCLUDE LOCKNUT AND NEOPRENE O-RING SEAL PROVIDE IMPACT RESISTANT 105 DEGREE C PLASTIC BUSINGS TO PROTECT CABLE INSULATION.</p> <p>B. CABLE TERMINATION FITTINGS FOR CONDUIT</p> <ol style="list-style-type: none"> <li>1. CABLE TERMINATORS FOR ROG CONDUITS SHALL BE TYPE CRC BY 0-Z/GENDEY OR EQUAL.</li> <li>2. CABLE TERMINATORS FOR LFMC SHALL BE ETICO – CL2075; OR MADE FOR THE PURPOSE PRODUCTS BY ROXTEC.</li> </ol> <p>C. EXTERIOR PULL BOXES AND PULL BOXES IN INTERIOR INDUSTRIAL AREAS SHALL BE PLATED CAST ALLOY, HEAVY DUTY METALFORGE, PLASTIC COVERS WITH GASKETED WAB SERIES OR EQUAL.</p> <p>D. CONDUIT OUTLET BODIES SHALL BE PLATED CAST ALLOY WITH SIMILAR GASKETED FOR COVERS. OUTLET BODIES SHALL BE OF THE CONFIGURATION AND SIZE SUITABLE FOR</p>	<p>THE APPLICATION. PROVIDE GROUZE-HINDS FORM B OR EQUAL.</p> <p>E. MANUFACTURER FOR BOXES AND COVERS SHALL BE HOFFMAN, SQUARE "H".</p> <p>F. GROUZE-HINDS, COOPER, AIALET, APPLETON, O-Z/GENDEY, RACO, OR APPROVED EQUAL.</p> <p><b>SUPPLEMENTAL GROUNDING SYSTEM</b></p> <p>A. FURNISH AND INSTALL A SUPPLEMENTAL GROUNDING SYSTEM AS INDICATED ON THE DRAWINGS. SUPPORT GROUNDS, GROUNNING CONNECTORS SHALL BE TINNED COPPER WIRE OR INSULATED CONDUCTORS AS INDICATED.</p> <p>B. SUPPLEMENTAL GROUNDING SYSTEM: ALL CONNECTIONS TO BE MADE WITH CWD WELDS, EXCEPT AT EQUIPMENT USE LUGS OR OTHER AVAILABLE GROUNNING MEANS AS REQUIRED BY MANUFACTURER; AT GROUND BARS USE TWO HOLE SPADES WITH NO OX.</p> <p>C. STOLEN GROUND-BARS: IN THE EVENT OF STOLEN GROUND BARS, CONTACT SPRINT CM FOR REPLACEMENT INSTRUCTION USING THREADED ROD KITS.</p> <p><b>EXISTING STRUCTURE:</b></p> <p>A. EXISTING EXPOSED WIRING AND ALL EXPOSED OUTLETS, RECEPTACLES, SWITCHES, DEVICES, BOXES, AND OTHER EQUIPMENT THAT ARE NOT TO BE UTILIZED IN THE COMPLETED PROJECT, SHALL BE REMOVED OR DE-ENERGIZED AND CAPPED IN THE WALL, CEILING, OR FLOOR SO THAT THEY ARE CONCEALED AND SAFE. WALL, CEILING, OR FLOOR SHALL BE PATCHED TO MATCH THE ADJACENT CONSTRUCTION.</p> <p><b>CONDUIT AND CONDUCTOR INSTALLATION:</b></p> <p>A. CONDUITS SHALL BE FASTENED SECURELY IN PLACE WITH APPROVED DEVICES FOR TACKING HANGERS. EXPLODE DEVICES FOR TACKING HANGERS TO CONDUIT, CLOTH TAPE, AND ZIP TIES MAY BE USED TO SECURE CONDUIT TO THE STRUCTURE AND TO MAINTAIN CLOSE CLEARANCE TO THE CONDUIT AND TO THE EXISTING CONDUIT. CONDUIT SHALL BE ROUTED AROUND OBSTACLES IN TIGHT ENVELOPE CHANGES IN DIRECTION TO THE OUTLET BODY. CONDUIT SHALL BE INSTALLED IN A NEAT AND WORKMANLIKE MANNER, PARALLEL, AND PERPENDICULAR TO STRUCTURE, WALL, AND CEILING LINES. ALL CONDUIT SHALL BE FIRED TO CLEAR OBSTACLES. ENDS OF CONDUITS SHALL BE TEMPORARILY CAPPED TO PREVENT CONCRETE, PASTER OR DIRT FROM ENTERING. CONDUITS SHALL BE RIGIDLY CLAMPED TO BOXES BY GALVANIZED IRON BUSHING OR IRON BUSHING ON INSIDE AND GALVANIZED MALLEABLE IRON LOCKRING ON OUTSIDE AND INSIDE.</p> <p>B. CONDUCTORS SHALL BE PULLED IN ACCORDANCE WITH ACCEPTED GOOD PRACTICE.</p> <p>C. CONDUITS BETWEEN PVC AND RIGID (RG) SHALL BE MADE WITH PVC COATED METALLIC LONG SWEEP RADIOS ELBOWS.</p> <p>D. ALL UNDERGROUND CONDUIT OR CONDUIT IN CONCRETE SHOULD BE PVC, EXIT OR RIGID GALVANIZED STEEL CONDUIT MAY BE USED IN FINISHED SPACES CONCEALED IN WALLS AND CEILINGS. EXIT SHALL BE MILD STEEL, ELECTRICALLY WELDED, AND PRODUCED TO ANSI STC-001, LISTED. EXTERIOR CONDUIT SHALL BE HOT DIP GALVANIZED AND SHALL BE MANUFACTURED BY ALLIED, REPUBLIC, OR WHEATLAND. 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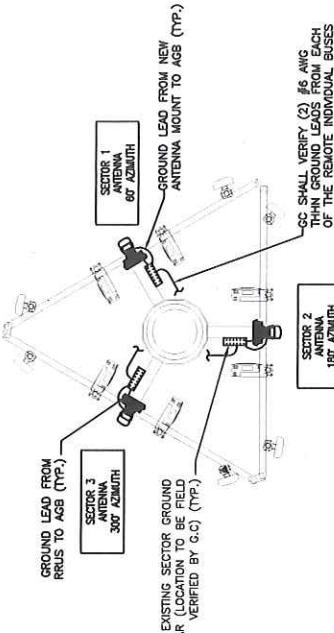
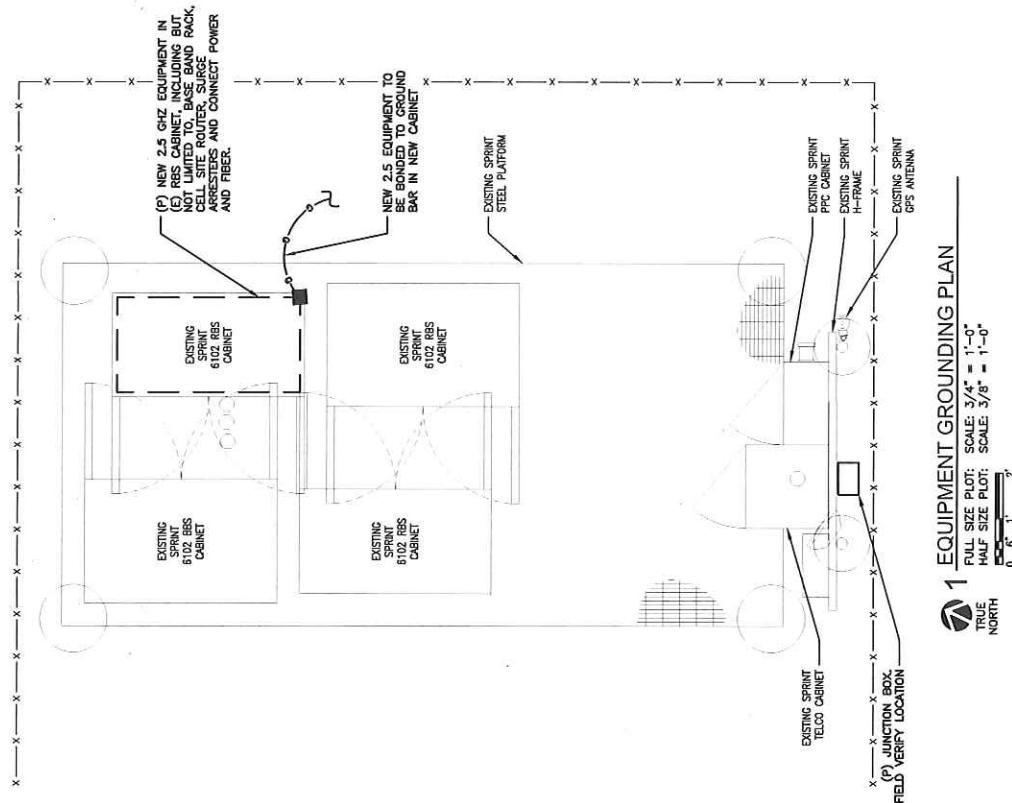
<p><b>Sprint</b></p> <p>6391 SPRINT PARKWAY OVERLAND PARK, KANSAS 66251</p> <p>PREPARED FOR:</p>	<p><b>VERTICOM</b> 10 &amp; B. SOLUTIONS, RESULTS. 7901 AMBASSADOR ROW DALLAS, TX 75247 214-741-6898</p> <p>PREPARED FOR:</p>	<p><b>ARIA SERVICES, INC.</b> 100 N. 1170 E., SUITE 4307 www.aria-corp.com</p> <p>PREPARED BY:</p>	<p><b>LEAGUE CITY COUNTRYSIDE WT</b></p> <p><b>SITE NUMBER: HO58XC335</b></p> <p><b>SITE ADDRESS: 5123 1/2 CANDLEWOOD LEAGUE CITY, TX 77573 GALVESTON COUNTY</b></p> <p><b>STAMP:</b></p> <p>I CERTIFY THAT THESE DRAWINGS WERE PREPARED BY ME OR UNDER MY DIRECT SUPERVISION &amp; CONTROL &amp; TO THE BEST OF MY KNOWLEDGE &amp; BELIEF TO COMPLY WITH THE REQUIRED CODES.</p>	<p><b>REVISION HISTORY</b></p> <table border="1" style="width: 100%; border-collapse: collapse;"> <tr> <td>NO</td> <td>DESCRIPTION</td> <td>BY</td> <td>DATE</td> </tr> <tr> <td>△</td> <td>SUBMISSION: 9/26/16</td> <td>SB</td> <td>11/03/16</td> </tr> <tr> <td></td> <td></td> <td></td> <td></td> </tr> </table>	NO	DESCRIPTION	BY	DATE	△	SUBMISSION: 9/26/16	SB	11/03/16																													<p><b>SHEET TITLE: OVERALL SITE PLAN</b></p> <p><b>SHEET NUMBER: A-1</b></p>
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<p><b>Sprint</b></p> <p>PREPARED FOR:</p>	<p><b>VERTICOM</b></p> <p>6391 SPRINT PARKWAY 7901 AMBASSADOR ROW DALLAS, TX 75247 214-741-6696</p> <p>PREPARED FOR:</p>	<p><b>ARIA SERVICES, INC.</b> (888) 111 7374-3307 www.aria-corp.com</p> <p>PREPARED BY:</p>	<p><b>LEAGUE CITY COUNTRYSIDE WT</b></p> <p>SITE NUMBER: <b>HO58XC335</b></p> <p>STAMP:</p> <p>I CERTIFY THAT THESE DRAWINGS WERE PREPARED BY ME OR UNDER MY DIRECT SUPERVISION &amp; CONTROL &amp; TO THE BEST OF MY KNOWLEDGE &amp; BELIEF TO COMPLY WITH THE REQUIRED CODES.</p>	<p>REVISION HISTORY</p> <table border="1" style="width: 100%; border-collapse: collapse;"> <tr> <td>NO</td> <td>DESCRIPTION</td> <td>REVISION</td> <td>DATE</td> </tr> <tr> <td>△</td> <td>SUBMISSION: 90%</td> <td>CD</td> <td>SB 11/05/16</td> </tr> <tr> <td></td> <td></td> <td></td> <td></td> </tr> </table>	NO	DESCRIPTION	REVISION	DATE	△	SUBMISSION: 90%	CD	SB 11/05/16																																	<p><b>EQUIPMENT PLAN</b></p> <p>SHEET NUMBER: <b>A-2</b></p>
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<p><b>EQUIPMENT PLAN (PROPOSED)</b></p> <p>FULL SIZE PLOT: SCALE: 3/4" = 1'-0" HALF SIZE PLOT: SCALE: 3/8" = 1'-0"</p> <p>TRUE NORTH</p> <p>0 6 1 2</p>																																													
<p><b>REVED CONDUIT CALL OUTS</b></p> <p>(2A) PROPOSED 1" CONDUIT FOR FIBER &amp; ETHERNET (1 PER SECTOR, 3 TOTAL). FIBER &amp; ETHERNET WILL RUN FROM EXISTING SPRINT RBS CABINET TO EACH SECTOR.</p> <p>(2B) PROPOSED 1"-1/2" CONDUIT FOR AC POWER W/ SLOW CABLE (1 PER SECTOR, 3 TOTAL). POWER WILL RUN FROM EXISTING PPC TELCO CABINET TO JUNCTION BOX AT EQUIPMENT PLATFORM WHERE IT WILL SPLIT TO EACH SECTOR.</p>																																													



<p><b>Sprint</b> 6391 SPRINT PARKWAY OVERLAND PARK, KANSAS 66251</p> <p><b>VERTICOM</b> (CLASS. SOLUTIONS. RESULTS. 7901 AMBASSADOR ROW DALLAS, TX 75247 214-714-0696</p> <p><b>ARIA SERVICES, INC.</b> (281) 737-4307 www.aria-cdrp.com</p> <p><b>PREPARED FOR:</b></p>   	<p><b>PREPARED FOR:</b></p> <p><b>LEAGUE CITY COUNTRYSIDE WT</b> <b>SITE NUMBER: HO58XC335</b></p> <p><b>PREPARED BY:</b></p> <p><b>ARIA SERVICES, INC.</b> (281) 737-4307 www.aria-cdrp.com</p> <p><b>SITE ADDRESS:</b> 5125 1/2 CADILEWOOD LEAGUE CITY, TX 77573 GALVESTON COUNTY</p> <p><b>STAMP:</b> I CERTIFY THAT THESE DRAWINGS WERE PREPARED BY ME OR UNDER MY DIRECT SUPERVISION &amp; CONTROL &amp; TO THE BEST OF MY KNOWLEDGE &amp; BELIEF TO COMPLY WITH THE REQUIRED CODES.</p>										
<p><b>Top View</b></p>  <p><b>Bottom View</b></p>  <p><b>Front View</b></p> 	<p><b>ALPHA WIRELESS AN3286</b></p> <table border="1"> <thead> <tr> <th>PHYSICAL DIMENSIONS</th> <th>51.18" (H) x 6.25" (W) x 3.34" (D)</th> </tr> </thead> <tbody> <tr> <td>WEIGHT</td> <td>17.63 lbs</td> </tr> <tr> <td>RADIOME</td> <td>UV-STABILIZED PVC</td> </tr> <tr> <td>NET OPTIONS</td> <td>MANUAL ADJUST OR RCU</td> </tr> <tr> <td>MOUNTING KIT</td> <td>CL-V-102</td> </tr> </tbody> </table> <p><b>1 MINI MACRO RADIO DETAIL</b> SCALE: N.T.S.</p>  <p><b>2 ANTENNA DETAIL</b> SCALE: N.T.S.</p>  <p><b>3 DIN-RAIL W/ CORD WHIP &amp; SPD SPECS</b> SCALE: N.T.S.</p>  <p><b>4 ANTENNA MOUNT DETAIL</b> SCALE: N.T.S.</p> 	PHYSICAL DIMENSIONS	51.18" (H) x 6.25" (W) x 3.34" (D)	WEIGHT	17.63 lbs	RADIOME	UV-STABILIZED PVC	NET OPTIONS	MANUAL ADJUST OR RCU	MOUNTING KIT	CL-V-102
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RADIOME	UV-STABILIZED PVC										
NET OPTIONS	MANUAL ADJUST OR RCU										
MOUNTING KIT	CL-V-102										

<p><b>Sprint</b></p> <p>PREPARED FOR:</p> <p>4 F. Single-mode (DS2)</p>	<p><b>FREEDM® Fan-Out Tight-Buffed Cable,</b></p> <p><b>CORNING</b></p>	<p>Part Number: 00111-01</p>	<p><b>VERTICOM</b></p> <p>10 LAS. SOLUTIONS. RESULTS.</p> <p>7901 AMBASSADOR ROW DALLAS, TX 75247 214-741-0898</p>	<p><b>PREPARED FOR:</b></p> <p><b>VERTICOM</b></p> <p>10 LAS. SOLUTIONS. RESULTS.</p> <p>7901 AMBASSADOR ROW DALLAS, TX 75247 214-741-0898</p>	<p><b>PREPARED BY:</b></p> <p><b>ARIA SERVICES, INC.</b></p> <p>(281) 737-4307 www.aria-cdr.com</p>	<p><b>SITE NAME:</b> <b>LEAGUE CITY COUNTRYSIDE WT</b></p> <p><b>SITE NUMBER:</b> <b>HO58XC335</b></p> <p><b>SITE ADDRESS:</b> 5123 1/2 CANDLEWOOD LEAGUE CITY, TX 77573 GALVESTON COUNTY</p>	<p><b>STAMP:</b></p> <p>I CERTIFY THAT THESE DRAWINGS WERE PREPARED BY ME OR UNDER MY DIRECT SUPERVISION &amp; CONTROL &amp; BELIEVE TO COMPLY WITH THE REQUIRED CODES.</p>
<p><b>3-9-SOOOW ROYAL® MULTI-CONDUCTOR SOOW</b></p>		<p><b>ROYAL® 90°C Rubber Cord, 600 Volts.</b></p> <p><b>Flexible Stranding Flame and Ozone Resistant.</b></p> <p><b>Black Jacket, Rated -40°C to 90°C.</b></p> <p><b>RoHS Compliant, UL Listed and CSA Certified for Indoor and Outdoor Use.</b></p> <p><b>Provides Premium Oil Resistance, Water Resistant and High Flexibility.</b></p> <p><b>Excellent Abrasion Resistance. Rated Extra-Hard Usage.</b></p>					
<p><b>APPLICATIONS</b></p>		<p>Southwire Type SOOW Multi-Conductor Flexible Cords are permitted for use as specified by Article 400 and related articles of circuits, tools, heavy industrial, processing and construction equipment.</p>					
<p><b>SPECIFICATIONS</b></p>		<p>Southwire Type SOOW Multi-Conductor Flexible Cords comply with:</p> <ul style="list-style-type: none"> <li>• UL 62</li> <li>• CSA Standard 22.2 No. 49</li> <li>• MSHA Listed - P07-KA070015-MSHA</li> <li>• Federal and Military Specification J-C-580B</li> <li>• NEC Article 400</li> <li>• OSHA Acceptable</li> <li>• RohsREACH</li> <li>• Hazardous Locations: Class I Div. 1 and 2 per NFPA 70, 501, 140</li> </ul>					
<p><b>CONSTRUCTION</b></p>		<p>Southwire Type SOOW Multi-Conductor Flexible Cords are manufactured using bare flexible stranded Class K copper conductors, heat, moisture and oil resistant EPDM rubber insulation. The insulated conductors are cabled with non-wicking wax paper fillers, with a tissue-paper separator wrapped around the assembly to promote easier removal of the jacket. A heat, moisture and oil resistant flexible CPE jacket is extruded over the assembly to complete the construction. Sizes 18 AWG through 10 AWG fully annealed stranded bare copper per ASTM B-174. Some sizes may be subject to minimum order quantity.</p>					
<p><b>1 POWER CABLE DETAIL</b></p>		<p><b>2 FIBER AND ETHERNET CABLE DETAILS</b></p> <p><b>SCALE: N.T.S.</b></p>					
		<p><b>EQUIPMENT DETAILS</b></p> <p><b>SHEET NUMBER:</b> A-5</p>					
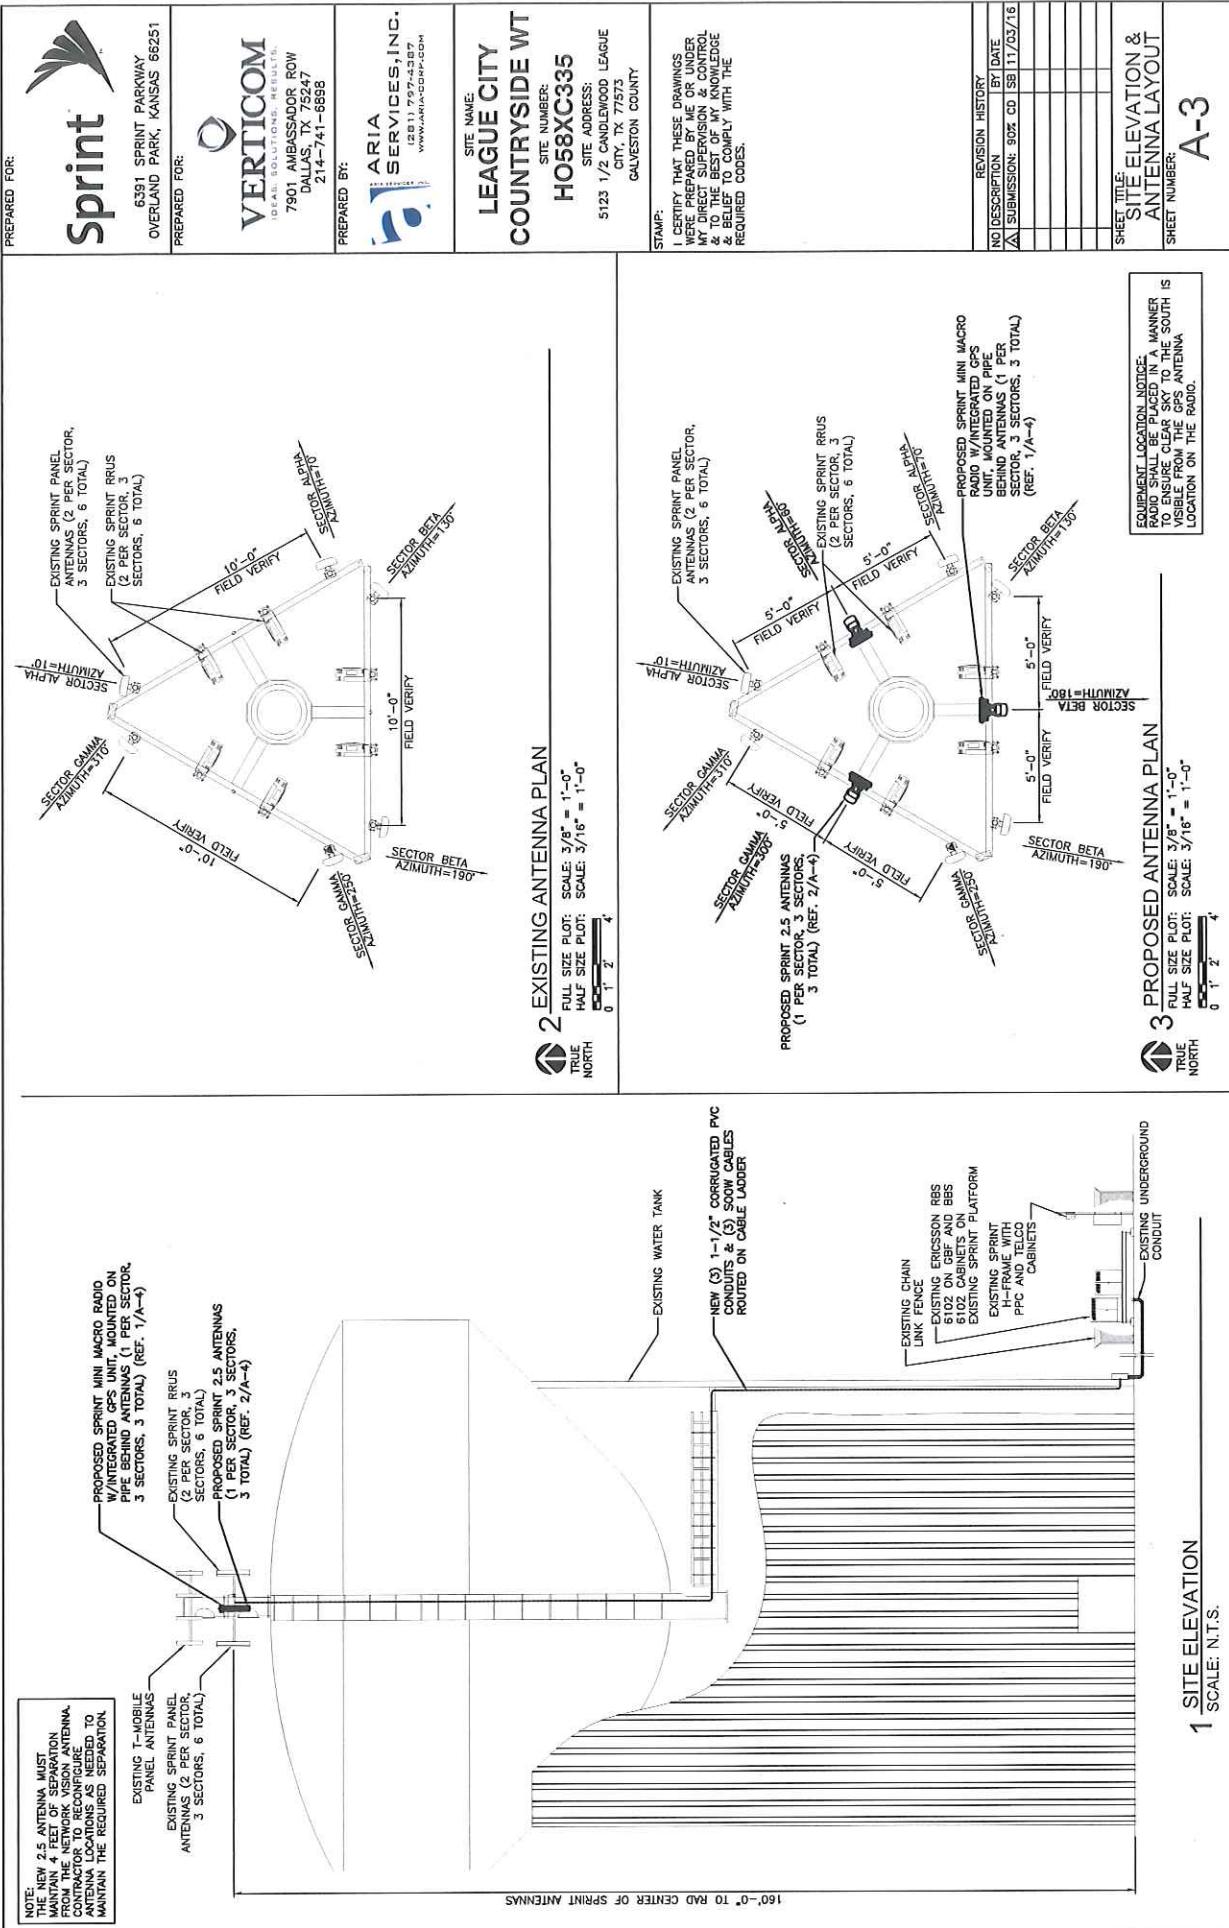
<p><b>Sprint</b> 6391 SPRINT PARKWAY OVERLAND PARK, KANSAS 66251</p> <p>PREPARED FOR:</p> 	<p><b>VERTICOM</b> 13641 SOLUTIONS, RESULTS. 7901 AMBASSADOR ROW DALLAS, TX 75247 214-741-6898</p> <p>PREPARED FOR:</p> 	<p>Site Name: <b>LEAGUE CITY COUNTRYSIDE WT</b></p> <p>Site Number: <b>HO58XC335</b></p> <p>Site Address: 5123 1/2 CANDLEWOOD LEAGUE CITY, TX 77573 GALVESTON COUNTY</p> <p>Stamp:</p> <p>I CERTIFY THAT THESE DRAWINGS WERE PREPARED BY ME OR UNDER MY DIRECT SUPERVISION &amp; CONTROL &amp; TO THE BEST OF MY KNOWLEDGE &amp; BELIEF TO COMPLY WITH THE REQUIRED CODES.</p>																								
<p><b>2 ANTENNA GROUNDING PLAN (TYP.)</b></p> <p>FULL SIZE PLOT: SCALE: <math>3/8'' = 1'-0''</math> HALF SIZE PLOT: SCALE: <math>3/16'' = 1'-0''</math></p> <p>TRUE NORTH</p> 																										
<p><b>1 EQUIPMENT GROUNDING PLAN</b></p> <p>FULL SIZE PLOT: SCALE: <math>3/4'' = 1'-0''</math> HALF SIZE PLOT: SCALE: <math>3/8'' = 1'-0''</math></p> <p>TRUE NORTH</p> <p>3 NOT USED</p> 																										
<p>Revision History</p> <table border="1"> <thead> <tr> <th>NO</th> <th>DESCRIPTION</th> <th>BY DATE</th> </tr> </thead> <tbody> <tr> <td>△</td> <td>SUBMISSION: 90% CD</td> <td>SB 11/03/16</td> </tr> <tr> <td></td> <td></td> <td></td> </tr> </tbody> </table> <p><b>SHEET TITLE</b> <b>GROUNDING &amp; ELECTRICAL PLAN</b></p> <p><b>SHEET NUMBER:</b> <b>E-1</b></p>			NO	DESCRIPTION	BY DATE	△	SUBMISSION: 90% CD	SB 11/03/16																		
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<p><b>Sprint</b></p> <p>PREPARED FOR:</p> <p><b>VERTICOM</b> 6391 SPRINT PARKWAY OVERLAND PARK, KANSAS 66251</p> <p>PREPARED FOR:</p> <p><b>ARIA SERVICES, INC.</b> (888) 777-4307 www.aria-cdp.com</p> <p>PREPARED BY:</p> <p><b>LEAGUE CITY COUNTRYSIDE WT</b> SITE NUMBER: <b>HO58XC335</b></p> <p>STAMP:</p> <p>I CERTIFY THAT THESE DRAWINGS WERE PREPARED BY ME OR UNDER MY DIRECT SUPERVISION &amp; CONTROL &amp; TO THE BEST OF MY KNOWLEDGE &amp; BELIEF TO COMPLY WITH THE REQUIRED CODES.</p>	<p>NOTES:</p> <ol style="list-style-type: none"> <li>1. APPLY NO-ox TO LUG AND BAR CONTACT SURFACE. DO NOT COAT INLINE LUG</li> <li>2. IF STOLEN GROUND BARS ARE ENCOUNTERED, CONTACT SPRINT CM FOR REPLACEMENT THREADED ROD KIT.</li> </ol> <p>#4 OR #6 AWG SOLID CU CONDUCTOR WITH GREEN, 600V, THHN-2 INSULATION</p> <p>(E) GROUNDING BAR ON WALL, FLOOR OR ON ANTENNA TOWER TWO HOLE PLATE TO BE USED TO CONNECT TO GROUND BAR</p> <p><b>INSTALLATION OF GROUND CONDUCTOR TO GROUND BAR</b> SCALE: N.T.S.</p>	<p><b>INSTALLED MOUNTING PIPE (TYP.)</b> <b>INSTALL ANTENNAS (TYP.)</b> <b>JUMPER CABLES (TYP.)</b> <b>INSTALL RRU (TYP.)</b> <b>FIBER &amp; ETHERNET CABLES (TYP.)</b> <b>SECTOR 1</b> <b>SECTOR 2</b> <b>SECTOR 3</b> <b>BBU</b> <b>EXISTING RBS RBS RECIFIER</b> <b>EXISTING N.V. RBS RECIFIER</b> <b>INSTALL ETHERNET/FIBER CABLE (TYP.)</b> <b>EXISTING MAIN GROUND BAR</b></p> <p><b>GROUND RISER DIAGRAM (TYP.)</b> SCALE: N.T.S.</p>	<p><b>INSPECTION WINDOW REQUIRED FOR ALL INTERIOR &amp; TWO-HOLE CONNECTORS</b></p> <p><b>EXTERNAL TOOTH</b></p> <p><b>3/8" x 1-1/2"</b></p> <p><b>S/S NUT</b></p> <p><b>S/S LOCK WASHER</b></p> <p><b>S/S FLAT WASHER</b></p> <p><b>APPLY NO-ox</b></p> <p><b>S/S FLAT WASHER</b></p> <p><b>S/S BOLT (1 of 2)</b></p> <p><b>GND BAR</b></p> <p><b>TINNED COPPER GND BAR</b></p> <p><b>HEAT SHRINK OR APPROVED EQUAL ON ALL LUGS</b></p> <p><b>HEAT SHRINK OR APPROVED EQUAL ON ALL LUGS</b></p> <p><b>LABEL</b></p> <p><b>1" MIN.</b></p> <p><b>1/4" MIN.</b></p> <p><b>HEAT SHRINK OR APPROVED EQUAL ON ALL LUGS</b></p> <p><b>REVISION HISTORY</b></p> <p>NO DESCRIPTION: 902C BY DATE: SB 11/03/16</p> <p>△ SUBMISSION: 902C BY DATE: SB 11/03/16</p> <p><b>SHEET TITLE: GROUNDING DETAILS</b> SHEET NUMBER: <b>E-2</b></p>
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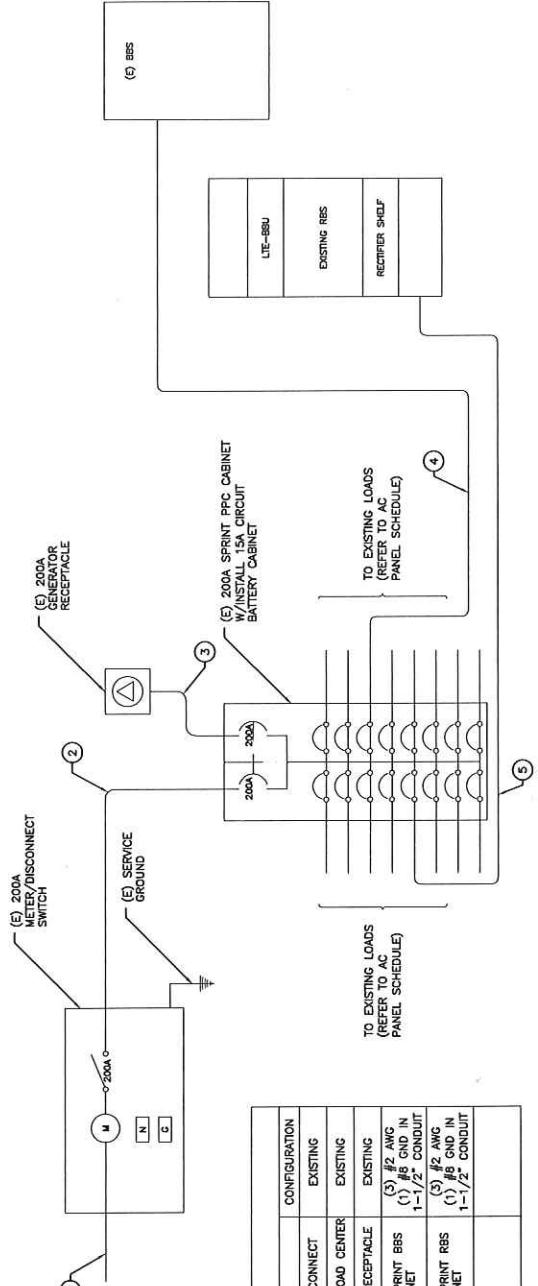
**5 TWO HOLE LUG**  
SCALE: N.T.S.

**4 NOT USED**

**3 NOT USED**

<p><b>Sprint</b></p> <p>PREPARED FOR:</p> <p>6391 SPRINT PARKWAY OVERLAND PARK, KANSAS 66251</p> <p>PREPARED FOR:</p>  <p><b>VERTICOM</b> 10844 SOUTHERN AVENUE 7901 AMBASSADOR ROW DALLAS, TX 75247 214-741-6698</p> <p>PREPARED BY:</p>  <p><b>ARIA SERVICES, INC.</b> (888) 777-4337 www.aria-cdp.com</p> <p>SITE NAME: <b>LEAGUE CITY COUNTRYSIDE WT</b></p> <p>SITE NUMBER: <b>H058XC335</b></p> <p>SITE ADDRESS: 5123 1/2 CANDLEWOOD LEAGUE CITY, TX 77573 GALVESTON COUNTY</p> <p>STAMP: I CERTIFY THAT THESE DRAWINGS WERE PREPARED BY ME OR UNDER MY DIRECT SUPERVISION &amp; CONTROL &amp; TO THE BEST OF MY KNOWLEDGE &amp; BELIEF TO COMPLY WITH THE REQUIRED CODES.</p> <p><b>DC ONE LINE DIAGRAM</b> SCALE: N.T.S.</p> <p><b>2 DC POWER DISTRIBUTION</b> SCALE: N.T.S.</p> <p><b>3 NOT USED</b></p> <p><b>4 NOT USED</b></p>	<p>PREPARED FOR:</p> <p>6391 SPRINT PARKWAY OVERLAND PARK, KANSAS 66251</p> <p>PREPARED FOR:</p>  <p><b>VERTICOM</b> 10844 SOUTHERN AVENUE 7901 AMBASSADOR ROW DALLAS, TX 75247 214-741-6698</p> <p>PREPARED BY:</p>  <p><b>ARIA SERVICES, INC.</b> (888) 777-4337 www.aria-cdp.com</p> <p>SITE NAME: <b>LEAGUE CITY COUNTRYSIDE WT</b></p> <p>SITE NUMBER: <b>H058XC335</b></p> <p>SITE ADDRESS: 5123 1/2 CANDLEWOOD LEAGUE CITY, TX 77573 GALVESTON COUNTY</p> <p>STAMP: I CERTIFY THAT THESE DRAWINGS WERE PREPARED BY ME OR UNDER MY DIRECT SUPERVISION &amp; CONTROL &amp; TO THE BEST OF MY KNOWLEDGE &amp; BELIEF TO COMPLY WITH THE REQUIRED CODES.</p> <p><b>DC ONE LINE DIAGRAM</b> SCALE: N.T.S.</p> <p><b>2 DC POWER DISTRIBUTION</b> SCALE: N.T.S.</p> <p><b>3 NOT USED</b></p> <p><b>4 NOT USED</b></p>																								
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NOTE:  
CG SHALL REFERENCE ALL SPECS FOR  
"CONNECTING THE POWER SUPPLY" OF  
THE NEW INSTALLATION DOCUMENTS.  
FOR ALL CONNECTION SPECIFICATIONS.

<p>Sprint</p> <p>PREPARED FOR:</p>	<p>VERTICOM</p> <p>6391 SPRINT PARKWAY OVERLAND PARK, KANSAS 66251</p> <p>PREPARED FOR:</p>	<p>PREPARED BY:</p>	<p>REVISION HISTORY</p>																								
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<p>CIRCUIT SCHEDULE</p> <table border="1" style="width: 100%; border-collapse: collapse;"> <thead> <tr> <th>NO</th> <th>FROM</th> <th>TO</th> <th>CONFIGURATION</th> </tr> </thead> <tbody> <tr> <td>①</td> <td>UTILITY SERVICE</td> <td>METER/DISCONNECT</td> <td>EXISTING</td> </tr> <tr> <td>②</td> <td>METER/DISCONNECT</td> <td>TRANSFER &amp; LOAD CENTER</td> <td>EXISTING</td> </tr> <tr> <td>③</td> <td>TRANSFER &amp; LOAD CENTER</td> <td>GENERATOR RECEPTACLE</td> <td>EXISTING</td> </tr> <tr> <td>④</td> <td>TRANSFER &amp; LOAD CENTER</td> <td>EXISTING SPRINT BBS CABINET</td> <td>(3) #2 AWG (1) #8 GND IN 1-1/2" CONDUIT</td> </tr> <tr> <td>⑤</td> <td>TRANSFER &amp; LOAD CENTER</td> <td>EXISTING SPRINT RES CABINET</td> <td>(3) #2 AWG (1) #8 GND IN 1-1/2" CONDUIT</td> </tr> </tbody> </table>		NO	FROM	TO	CONFIGURATION	①	UTILITY SERVICE	METER/DISCONNECT	EXISTING	②	METER/DISCONNECT	TRANSFER & LOAD CENTER	EXISTING	③	TRANSFER & LOAD CENTER	GENERATOR RECEPTACLE	EXISTING	④	TRANSFER & LOAD CENTER	EXISTING SPRINT BBS CABINET	(3) #2 AWG (1) #8 GND IN 1-1/2" CONDUIT	⑤	TRANSFER & LOAD CENTER	EXISTING SPRINT RES CABINET	(3) #2 AWG (1) #8 GND IN 1-1/2" CONDUIT	<p>STAMP:</p> <p>I CERTIFY THAT THESE DRAWINGS WERE PREPARED BY ME OR UNDER MY DIRECT SUPERVISION &amp; CONTROL &amp; TO THE BEST OF MY KNOWLEDGE &amp; BELIEF TO COMPLY WITH THE REQUIRED CODES.</p>	
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<p>SHEET NUMBER:</p>		<p>E-4</p>																									
<p>2 NOT USED</p>		<p>3 NOT USED</p>																									

## ABBREVIATIONS WHERE APPLICABLE

ADJ.	MINOR
APPROX.	METAL
CABINET	NIC
CLL.	NOT IN CONTRACT
CONCRETE	NTS
CONF.	ON CENTER
COST	OCP
CONSTRUCTION JOINT	OPP
C.J.	SQUARE FOOT
DIA.	SHEET
DRAWER	SHR
DUG	SIMILAR
EACH	STL
EQUIPMENT GROUND BAR	SS
ELEC.	STEEL
ELEVATION	TOP OF CONCRETE
EQ.	TOP OF MASONRY
EQUIPMENT EXTERIOR	TOP OF TYPICAL
EXT.	TOP OF VF
FF.	UNLESS OTHERWISE NOTED
FINISHED FLOOR	WAF
GANGE	WAFFLE
GA.	WAFFLE FABRIC
GALVANIZED	WAFFLE CENTERLINE
GENERAL CONTRACTOR	PLATE
GROUND	P
LONG.	ASL ABOVE GRADE LEVEL
L.A.	ASL ABOVE MEAN SEA LEVEL
MAX.	MAXIMUM
MCH.	MCHANICAL
MANUFACTURER	MANUFACTURER
MASTER ISOLATED GROUND BAR	MISB

# Sprint PCS<sup>SM</sup> -HOUSTON


## CASCADE # H058XC335

### LEAGUE CITY WATER TOWER

5123 1/2 CANDLEWOOD DRIVE  
LEAGUE CITY, TEXAS 77573  
COUNTY OF GALVESTON, TEXAS  
EXISTING WATER TOWER COMMUNICATION SITE

LATITUDE: N 29° 29' 57.25" NAD 83  
LONGITUDE: W 95° 08' 33.68" NAD 83  
ELEVATION: 249 ft ASL (ANSL NAVD88)

## SYMBOLS AND MATERIALS WHERE APPLICABLE

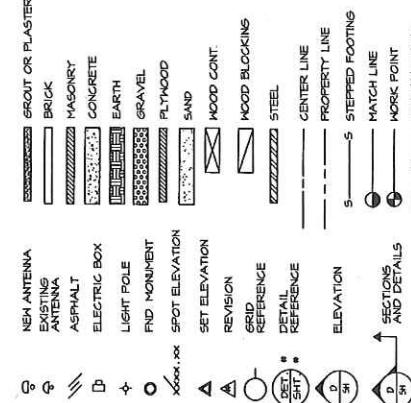

CONTRACTOR SHALL REFER TO SPRINT PCS DETAILED SPECIFICATIONS FOR CELL SITES FOR ANY ITEMS OR WORK NOT LISTED OR DETAILED HEREIN. STANDARD SPECIFICATIONS SHALL SUPERSEDE WHERE CONFLICTS OCCUR.


CONTRACTOR SHALL VERIFY ALL PLANS AND EXISTINGS DETAILED IN THIS DRAWING. IF ANY DISCRENCES OCCUR, THE CONTRACTOR SHALL IMMEDIATELY NOTIFY THE ENGINEER IN WRITING OF ANY DISCRENCES BEFORE PROCEEDING WITH THE WORK OR BE RESPONSIBLE FOR SAME.




IRVING, TEXAS 75039  
SUITE 300  
5030 RIVERSIDE DRIVE

SUITER 300  
5030 RIVERSIDE DRIVE  
IRVING, TEXAS 75039

Sprint PCS<sup>SM</sup>

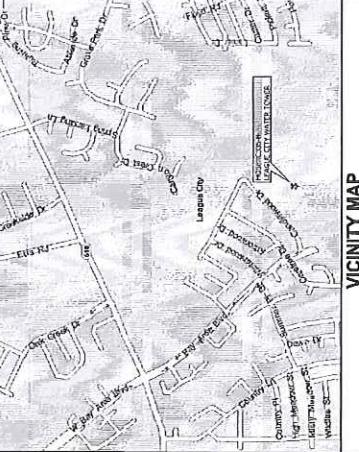

VICINITY MAP

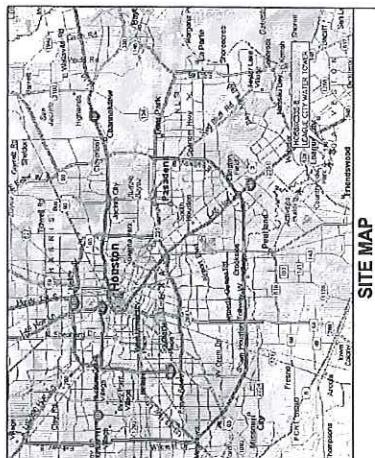


SITE MAP

 <b>W-T</b>	<small>W-T COMMUNICATION GROUP LLC 3001 LBJ FREEWAY, SUITE 120 DALLAS, TEXAS 75254 (972) 732-0101 (972) 732-0700</small>
<small>STATE OF TEXAS LEAGUE CITY WATER TOWER</small>	
<small>SCOTT R. TRAHANIN Project Manager CHRIS FEIFER - PECI ERIC KARPINSKI DIR DIRECTOR (281) 364-5425</small>	
<small>DATE: 05/26/04 DRAWING: 05/26/04</small>	
<small>PROJECT NO: T04277 DRAWN BY: TMC CHECKED BY: KWM</small>	
<small>CASCADE # H058XC335 LEAGUE CITY WATER TOWER</small>	
<small>5123 1/2 CANDLEWOOD LEAGUE CITY, TX 77573 GALVESTON COUNTY</small>	
<small>LANDLORD _____ SPRINT MGR _____ ELECTRICAL &amp; COMMUNICATION DESIGN GROUP TOWER SUPPLIER: SABRE COMMUNICATIONS ENGINEERS AND SUPPLIERS</small>	
<small>SURVEYOR: WEBB SURVEYING, INC. STRUCTURAL: PONTECK ELECTRICAL &amp; COMMUNICATION DESIGN GROUP TOWER SUPPLIER: SABRE COMMUNICATIONS</small>	
<small>UTILITIES</small>	
<small>ENTERTAINMENT BUSINESS DEVELOPMENT SOUTHWESTERN BELL TELEPHONE BUSINESS DEVELOPMENT (800) 245-4545</small>	
<small>TEXAS ONE CALL</small>	
<small>ZONING JURISDICTION: CITY OF LEAGUE CITY ZONING CLASSIFICATION: CITY EXEMPT APPLICANT: SPRINT PCS SUBMISSION: 5000 RIVERSIDE DRIVE SUITE 200 IRVING, TEXAS 75294</small>	
<small>CONTACT PERSON: ED LASKOWSKI CONTACT NO.: (281) 364-5425 FACILITY IS UNHANDED AND NOT FOR HUMAN HABITATION THEREFORE HANDICAP ACCESS IS NOT REQUIRED. NO PLUMBING ON SITE</small>	
<small>PROJECT SUMMARY</small>	
<small>CONTRACTOR TO UTILIZE INDEPENDENT UNDERGROUND UTILITY LOCATOR ON ALL SITES 48 HRS PRIOR TO DIGGING. TEXAS ONE CALL NUMBER IS (800) 245-4545</small>	
<small>UTILITIES</small>	
<small>FROM I-45 (NORTH PREMARIAL) ON DOWNTOWN APPROX 20 MILS TO PM SUNLEAF RD (JCT. BOY SCOUT RD) FOR 5 MILS ON BOY SCOUT RD TO SAW MILL RD. FOR 2 MILS ON SAW MILL RD TO LEEWARD DR. FOR 1 MIL ON LEEWARD DR TO CANDLEWOOD AND LEAGUE CITY WATER TOWER.</small>	
<small>DRIVING DIRECTIONS</small>	
<small>COPYRIGHT © 2004 BY W-T COMMUNICATION DESIGN GROUP LLC</small>	

T-1

SHEET NUMBER

	<p><b>SURVEY</b></p> <p><b>Sprint PCS</b></p> <p><b>Sprint Prepaid Domestic Service</b></p> <p><b>SITE NAME: LEGUE CITY WATER TOWER</b></p> <p><b>SITE NUMBER: H05BCX358</b></p> <p><b>FM 518/BAY AREA BLVD</b></p> <p><b>LEAGUE CITY, TX 77573</b></p>
--	---

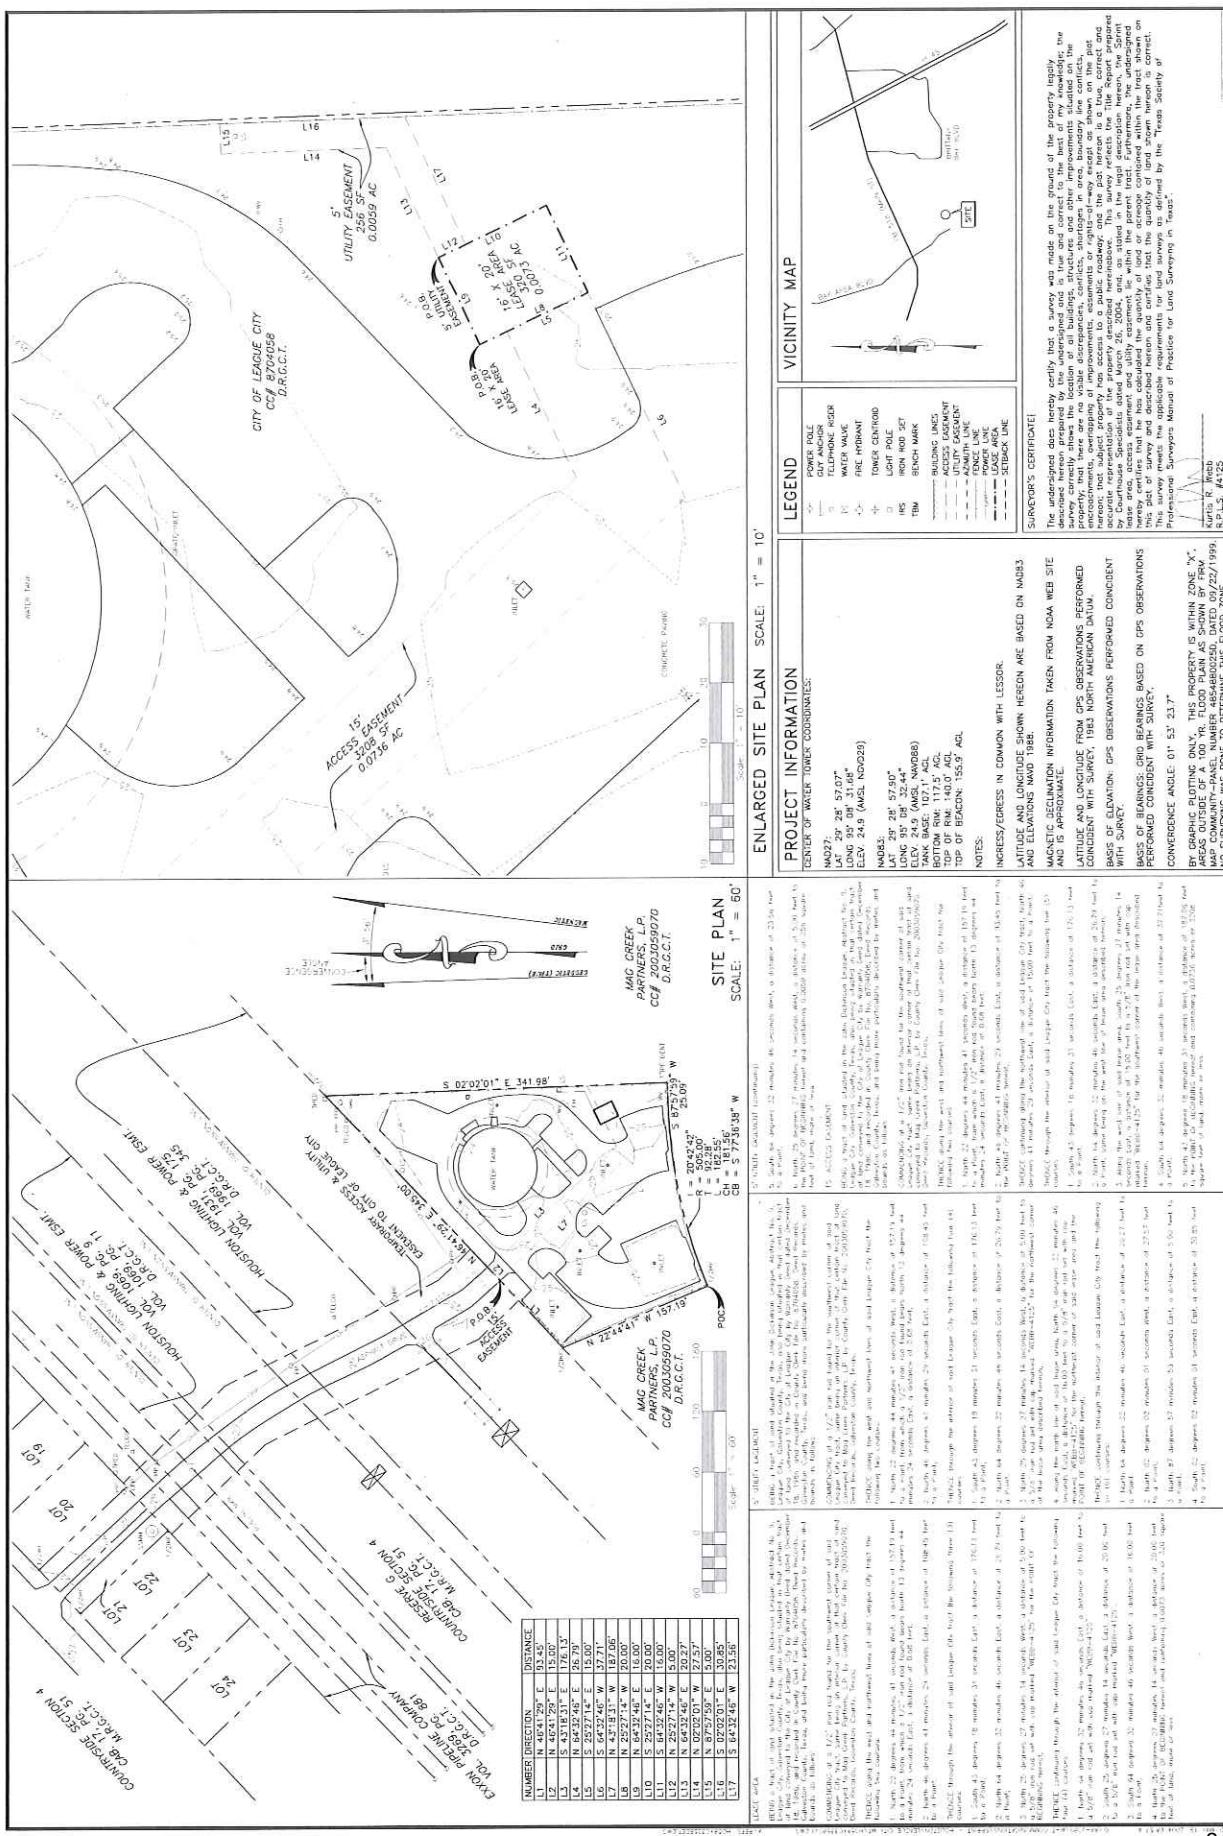

## GENERAL NOTES:

- CONTRACTOR SHALL COMPLY WITH ALL BUILDING CODES OF THE AUTHORITIES HAVING JURISDICTION
- NOTIFY THE SITE OWNER AND SITE MANAGER OF THE CONSTRUCTION START DATE.
- COORDINATE THE CONSTRUCTION SITING AREA WITH THE SITE OWNER AND SITE MANAGER WELL IN ADVANCE OF THE CONSTRUCTION START DATE.
- PROTECT THE EXISTING FACILITIES AT ALL TIMES. THE CONTRACTOR IS RESPONSIBLE FOR REPAIRING ANY DAMAGE CAUSED BY CONSTRUCTION OPERATIONS
- THE CONTRACT LIMITS ARE AS NOTED ON THE DRAWINGS. CONFINE OPERATION TO AREAS WITHIN THE LIMITS INDICATED
- PROVIDE FOR COMPLETE TELEPHONE AND ELECTRICAL SERVICE AS INDICATED ON THE DRAWINGS. COORDINATE WITH SITE OWNER AND AUTHORITIES HAVING JURISDICTION
- CONTRACTOR IS TO VERIFY THE EXACT LOCATION OF ALL EXISTING UTILITIES AND COORDINATE THE INSTALLATION OF NEW UTILITIES.
- CONTRACTOR IS TO FIELD VERIFY ALL EXISTING CONDITIONS AND PLAN DIMENSIONS AND NOTIFY THE ENGINEER IMMEDIATELY OF ANY DISCREPANCIES. DO NOT SCALE DRAWINGS
- THE CONTRACTOR SHALL REMOVE ALL TRASH AND DEBRIS FROM THE SITE ON A DAILY BASIS.
- THE EQUIPMENT LOCATIONS SHOWN SHALL NOT BE VARIED WITHOUT THE REVIEW AND APPROVAL OF THE ENGINEER
- EQUIPMENT PLATFORM AND ANTENNAS ARE DESIGNED TO MEET LOCAL BUILDING CODES, AND ANIS/VELATIA-22-E STRUCTURAL STANDARDS FOR STEEL ANTENNA SUPPORTING STRUCTURES. THE DESIGN AND SPEED IS TO MPH AND 1/2" ICE
- CONTRACT COMPANIES AND THEIR EMPLOYEES SHALL FOLLOW OSHA SAFETY GUIDELINES WHILE PERFORMING SERVICES
- WHERE A TOWER DOES NOT HAVE A PERMANENT FALL PROTECTION SYSTEM, THE CONTRACT COMPANY IS RESPONSIBLE FOR PROVIDING A SUITABLE SYSTEM FOR ITS EMPLOYEES
- CONTRACTOR SHALL PERFORM A SAFETY INSPECTION PRIOR TO COMMENCING ALL WORK AND RE-BEFORE A ZONE IS TURNED OVER. IF THE WORK IS FOUND TO CAUSE BODILY HARM OR ENDANGERMENT TO CONTRACTOR'S EMPLOYEE'S OR OTHERS, CONSTRUCTION CAN BE HALTED IMMEDIATELY UNTIL THE HAZARD IS REPORTED AND CORRECTED. THE SAFETY HAZARD, IF BE CORRECTED BY THE CONTRACTOR WHILE ON SITE, AFTER THE TIME THE PROBLEM SHOULD HAVE BEEN REPORTED, THE CONTRACTOR HAS RECEIVED APPROVAL FROM THE OWNER OF THE HAZARD, AND HAS RECEIVED APPROVAL FROM OWNER TO PERFORM THE CORRECTION.
- MONPOLE TOWER FOUNDATION DESIGN IS UNDER SEPARATE CONTRACT BY OTHERS AND IS EXCLUDED FROM THESE DRAWINGS. REFER TO OWNER PROVIDED DRAWINGS FOR SPECIFIC DETAILS REGARDING FOUNDATION SYSTEM.
- VERIFY WITH SPRINT PCS ENGINEER THE AZIMUTH AND ORIENTATION OF PLATFORM PRIOR TO INSTALLATION
- CONTRACTOR TO RESTORE ALL DAMAGED AREAS, CAUSED BY CONSTRUCTION TO INSTALLATION
- CONTRACTOR SHALL OBSERVE AND OBEY ALL WARNING SIGNS POSTED AT THIS SITE ORIGINAL CONDITION UPON COMPLETION OF CONSTRUCTION
- CONTRACTOR SHALL SUPPLY AT ALL TIMES DURING SITE PREPARATION, CONSTRUCTION, INSPECTION, AND TESTING ALL EQUIPMENT MATERIALS, AND SAFETY MANUALS PERTAINING TO OSHA THESE REQUIREMENTS ARE INCLOUDING BUT NOT LIMITED TO PORTABLE REST ROOMS, SAN SHADIES AND DRINKING WATER.

## CANDLEWOOD DRIVE (SIDE)

SEE SURVEY FOR LEGAL DESCRIPTION OF LEASE AREA,  
ACCES AND UTILITY EASEMENT

EXISTING ASPHALT  
ACSES ROAD TO BE  
USED FOR SPRINT  
ACCESS

IRVING, TEXAS 75039  
SUITE RIVERSIDE 300  
5030 RIVERSIDE DRIVE

**Sprint.PCS.**

**W-T**


W-T COMMUNICATION

DESIGN GROUP LLC

3001 LA PREDIO, SUITE 120  
DALLAS, TX 75234  
ph. (972) 739-0761  
fax. (972) 739-0762

1-15-2004 FOR CONSTRUCTION

A 1-15-2004 PRELIMINARY

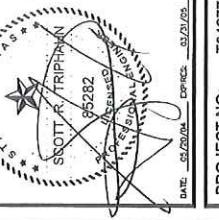

DATE:

5/12/04 DRAWN:

04-04

CHECKED BY:

KVM

PROJECT NO:

T04277

DRAWN BY:

TMC

checked by:

KVM

overall site plan

sheet title

CASCADE # HOBXK335


LEAGUE CITY

WATER TOWER

5123 1/2 CANDLEWOOD

GALVESTON COUNTY

25 of 54

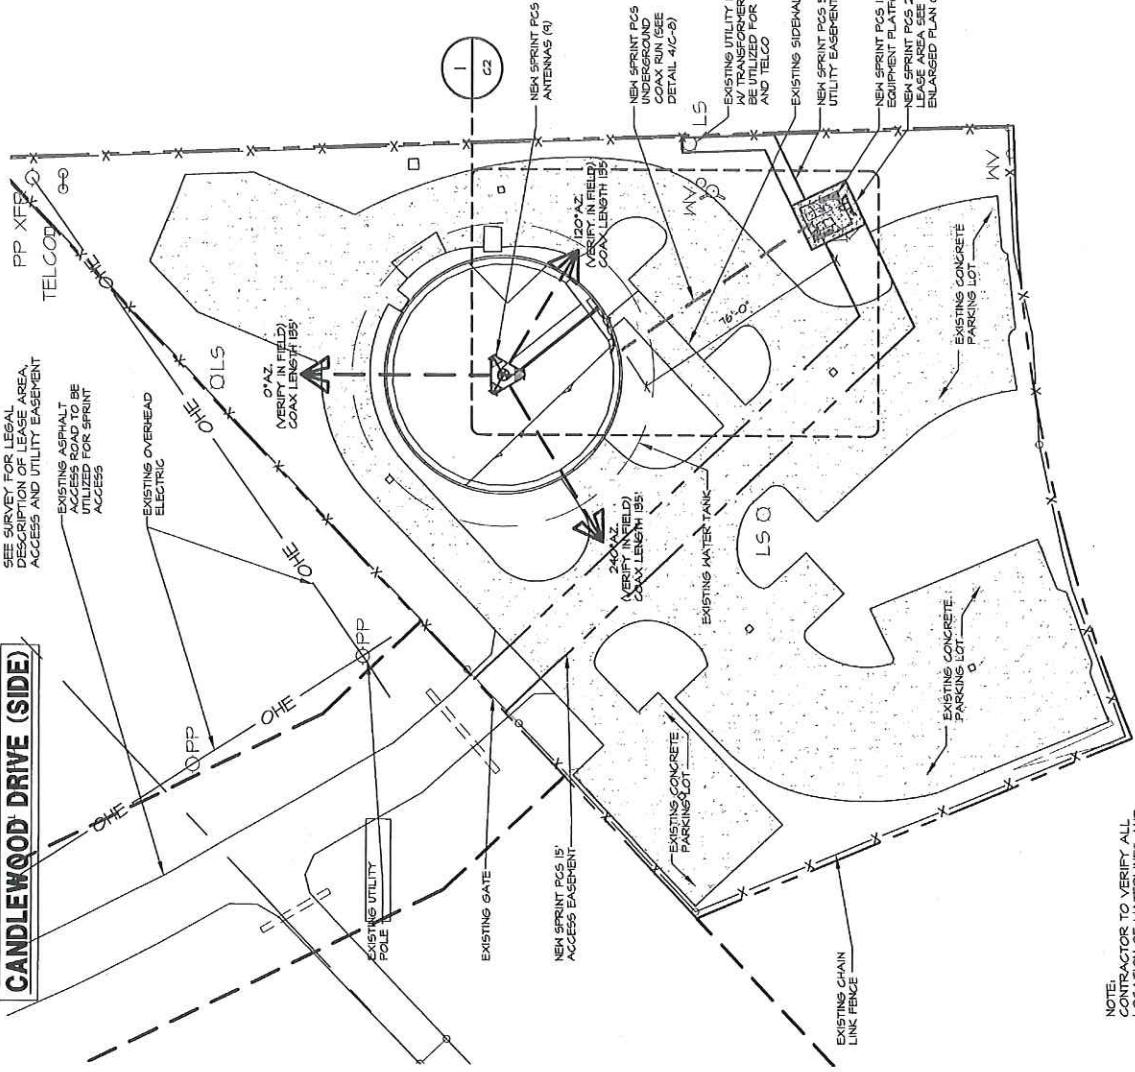

## OVERALL SITE PLAN



SCALE: 1" = 40'-0"

NOTE:  
CONTRACTOR TO VERIFY ALL  
LOCATION OF WATERLINES AND  
TO HAND DIG IN THAT AREA.

NOTE:  
DURING CONSTRUCTION, CONTRACTOR TO MAINTAIN A  
CONCRETE FENCE PERIMETER AROUND THE SITE AT ALL TIMES  
FOLLOWING CLOSE OF EVERY BUSINESS DAY

NOTE:  
CONTRACTOR SHALL PAINT TO  
MATCH ALL MATERIALS TO BE  
ATTACHED TO EXISTING TOWER

CFP-GHTRC 2004 BY W-T COMMUNICATION DESIGN GROUP LLC

SHEET NUMBER  
**C-1**

1


**Sprint PCS**

5030 RIVERFRONT DRIVE  
SUITE 300  
IRVING, TEXAS 75039


**W-T**


W-T COMMUNICATION  
DESIGN GROUP LLC

201 W. FRANCIS ST., SUITE 120  
DALLAS, TEXAS 75234  
PH: (972) 735-0761  
FAX: (972) 735-0762

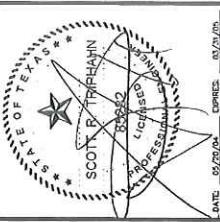

DATE: 05/20/04  
TIME: 03:15:00  
PROJECT NO: T04277  
DRAWN BY: TMC  
CHECKED BY: KWM  
CASCADe # H058XC35  
LEAGUE CITY  
WATER TOWER  
5123 1/2 CANDLEWOOD  
LEAGUE CITY, TX 77553  
GALVESTON COUNTY  
SHEET TITLE: ENLARGED SITE PLAN  
SHEET NUMBER: C-2

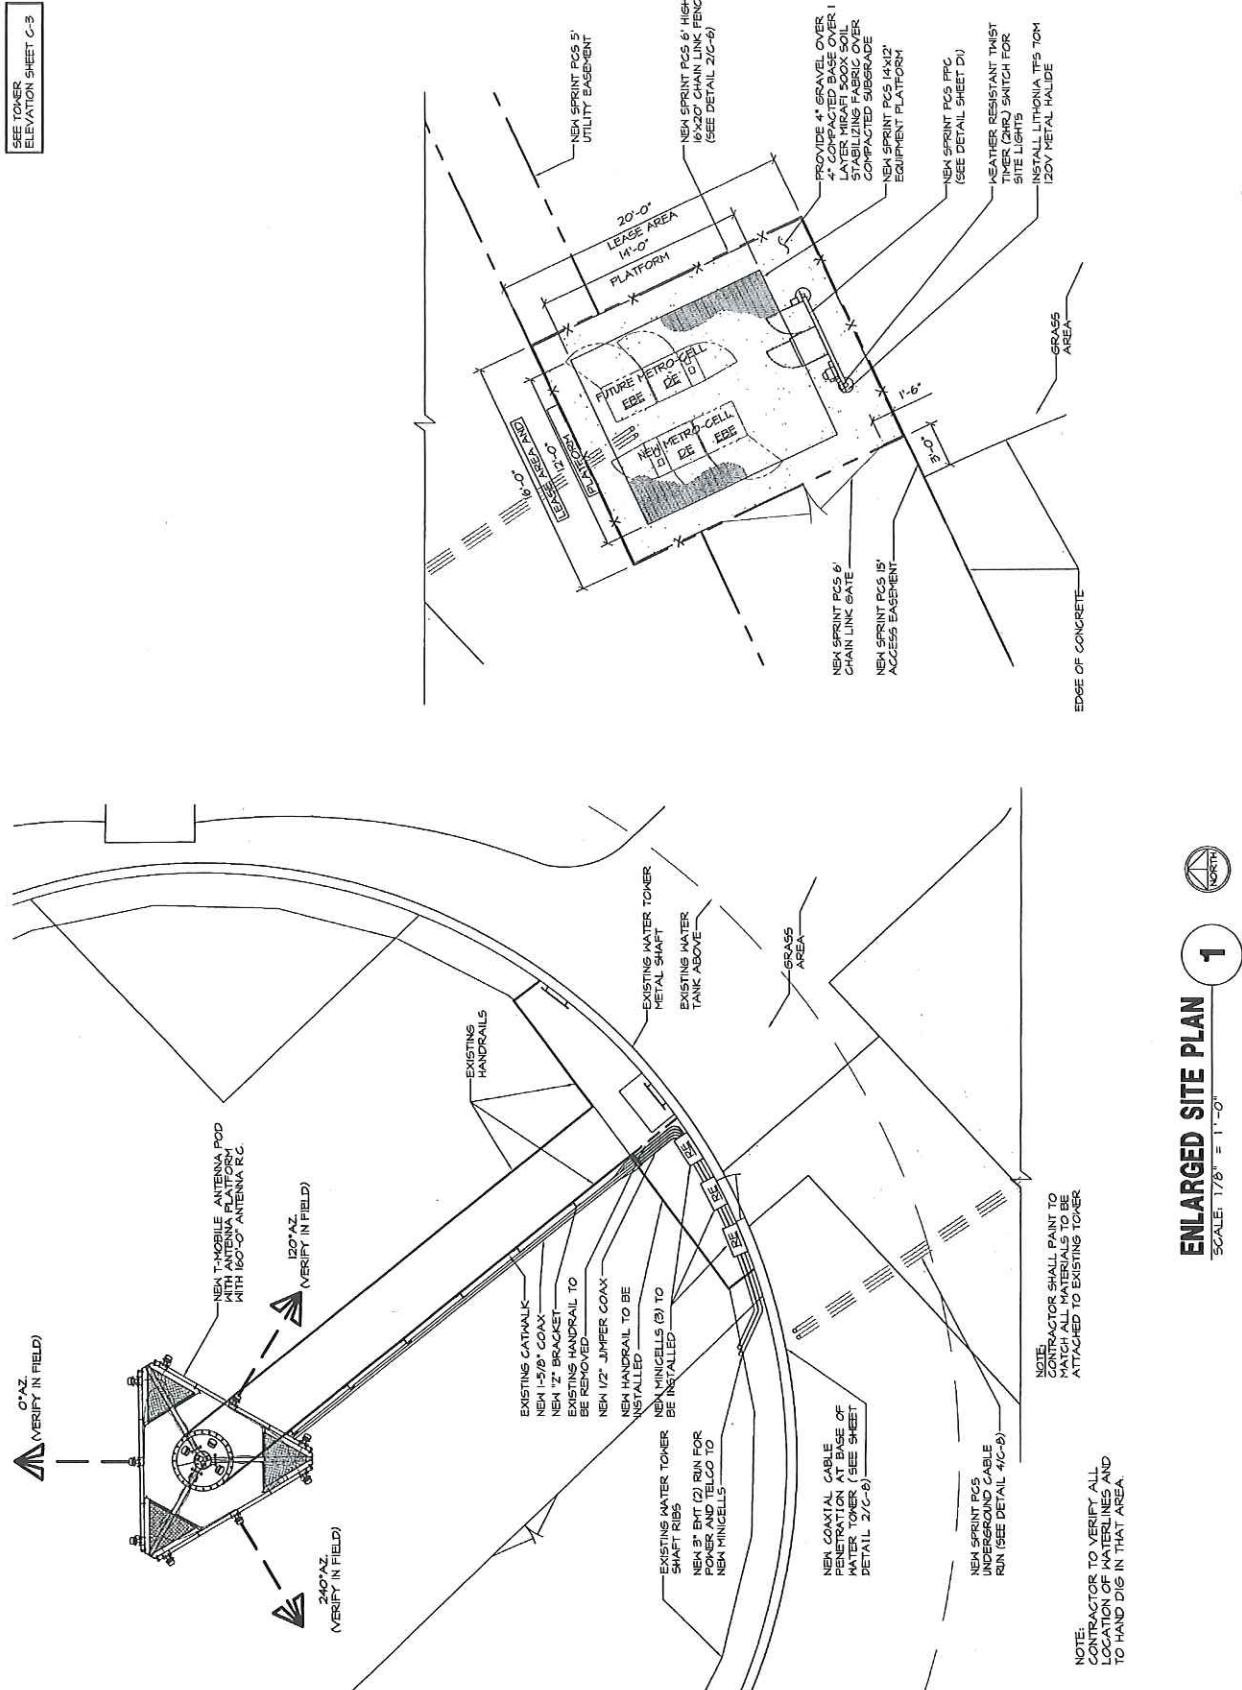

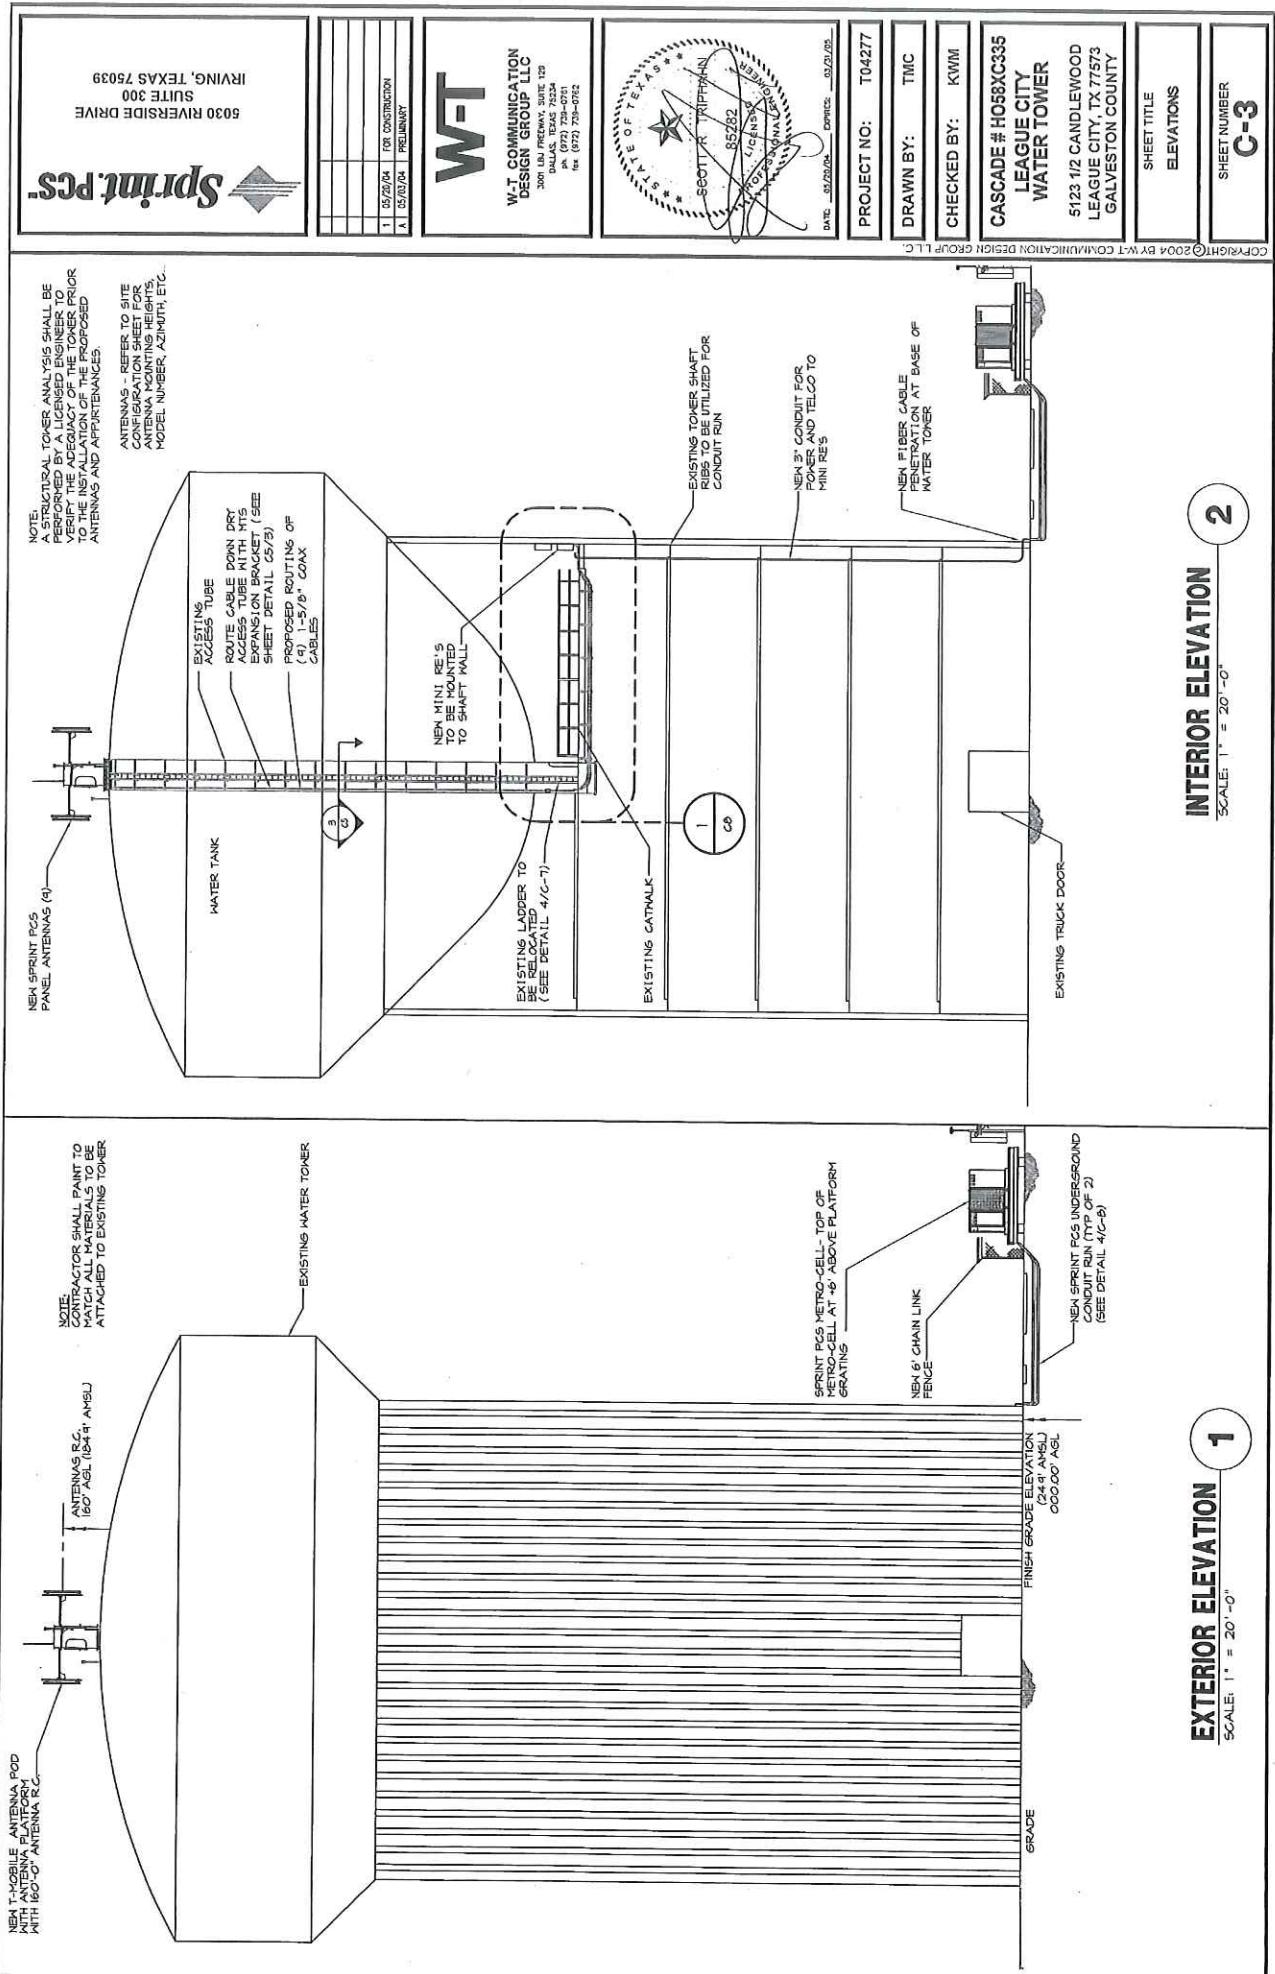

5030 RIVERESIDE DRIVE  
SUITE 300  
IRVING, TEXAS 75039



### COAX AND CABLE TRAY CHART

	ANTENNA	1ST RINGS	2ND RINGS	CABLE TRAY
ALPHA	TX/RX	YELLOW	BROWN	WHITE
	RX1	YELLOW	WHITE	WHITE
FUTURE	TX/RX	RED	BROWN	WHITE
	RX1	RED	WHITE	WHITE
FUTURE	TX/RX	GREEN	BROWN	WHITE
	RX1	GREEN	WHITE	WHITE
FUTURE	TX/RX	GREEN	WHITE	WHITE

COLOR CODE ALL ANTENNA AND COAX CABLES WITH 2" HI-DE BANDS OF COLORED TAPE WITH 1" SEPARATION BETWEEN BANDS AT 3 LOCATIONS.  
COLOR CODE ALL TOP AND BOTTOM GROUND LITS WITH 1" HI-DE BANDS OF COLORED TAPE WITH 1/2" SEPARATION BETWEEN BANDS.  
START COLOR BANDS 2" BEYOND WEATHERPROOFINGS.

ALL TOP JUMPS KILL BE MAX .10" IN LENGTH AND MIN. OF .05" IN LENGTH.  
ALL CABLES SHALL BE MARKED AT TOP AND BOTTOM WITH 2" COLORED TAPE AND STENCILING AS PER THE FOLLOWING TABLES:

W-T

W-T COMMUNICATIONS GROUP LLC  
205 LABORATORY SUITE 120  
DALLAS, TX 75243  
Ph: (972) 259-0711  
Fax: (972) 259-0712

### EQUIPMENT NOTES:


1. ALL CABLE TRAY SHALL HAVE A DIAMOND PLATE COVER
2. CONTRACTOR SHALL VERIFY EXACT DIMENSION BETWEEN ANTENNA MOUNTING BRACKETS WITH SPRINT PCS BEFORE INSTALLATION
3. ALL CONSTRUCTION SHALL BE IN ACCORDANCE WITH THE LATEST VERSION OF SPRINT PCS STANDARD CONSTRUCTION SPECIFICATIONS
4. ALL TIE HARPS SHALL BE THOMAS AND BETTS TT 512-2900, MULTI-LINK STAINLESS STEEL SELF-LOCKING CABLE TIES COATED WITH NYLON 11
5. PROVIDE COMPLETE CABLE TRAY SYSTEM IN-LINE 34XXX-18-144 OR EQUAL WIDTHS SHOWN ON DRAWINGS. GRAY FINISH UNLESS NOTED OTHERWISE.




RIGHT © 2004 BY W-T COMMUNICATIONS DESIGN GROUP LLC  
5123 1/2 CANDLEWOOD  
LEAGUE CITY, TX 77573  
GALVESTON COUNTY

SHEET TITLE  
CONSTRUCTION DETAILS  
SHEET NUMBER  
**C-4**

### ANTENNA AND CABLE COLOR CODING CHART

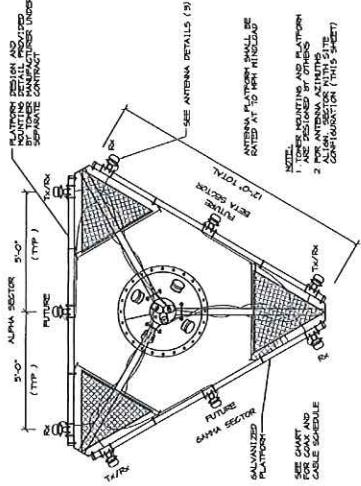


DOWNTILT ASSEMBLY  
REQUIRED FOR ALL  
PANEL TYPE  
ANTENNAS

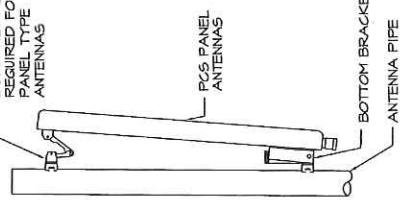

NOTE:  
VERIFY ANTENNA TYPE AND MODEL  
PRIOR TO INSTALL  
ALL HARDWARE SHALL BE COMPATIBLE  
WITH ANTENNA TYPE

### FRONT VIEW

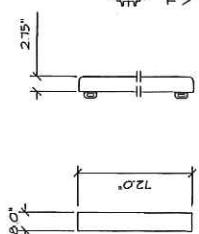

### SIDE VIEW

NOTE:  
VERIFY ANTENNA TYPE AND MODEL  
PRIOR TO INSTALL  
ALL HARDWARE SHALL BE COMPATIBLE  
WITH ANTENNA TYPE

### ENLARGED ANTENNA DETAIL

SCALE 1:1


**1**





IRVING, TEXAS 75039  
SUITE 300  
5030 RIVERSIDE DRIVE


Sprint PCS.

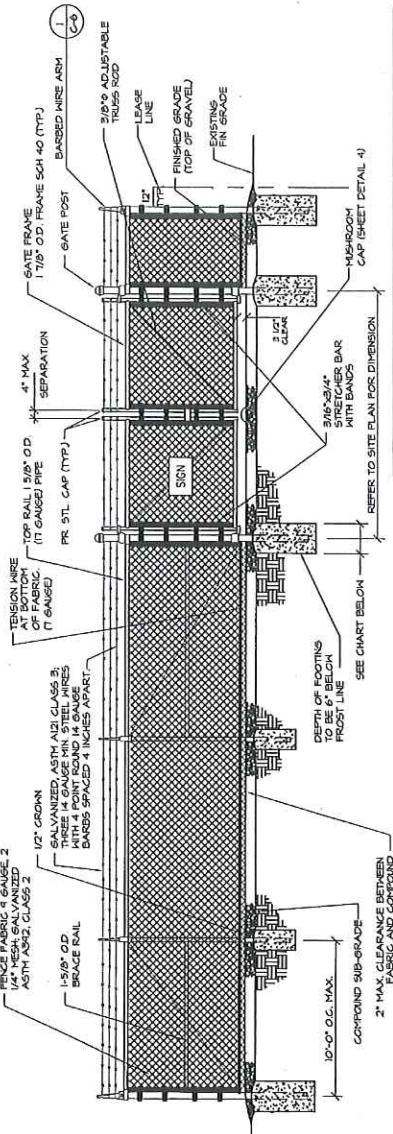

### BARBED WIRE ARM DETAIL (ARM OUT)

SCALE: N.T.S.


1

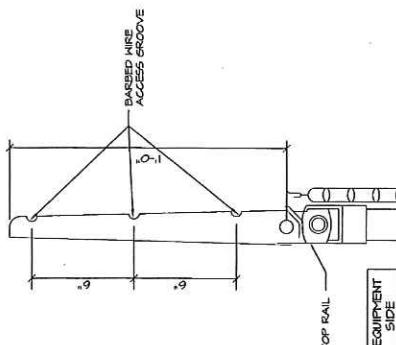

### TYPICAL FENCE AND DOUBLE GATE DETAIL (W/BARBED WIRE)

SCALE: N.T.S.

2

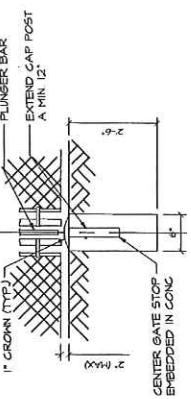

**NOT USED**


SCALE: N.T.S.

3

**MUSHROOM CAP DETAIL**

SCALE: N.T.S.

4

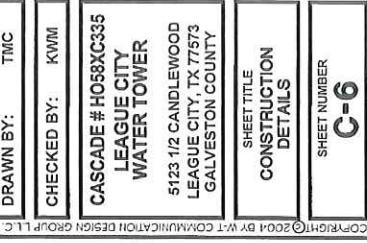

<p><b>Sprint PCS</b></p> <p>IRVING, TEXAS 75039 SUITE 300 5030 RIVERSIDE DRIVE</p>	<p>W-T</p> <p>W-T COMMUNICATIONS GROUP LLC 3000 FRONT ST., SUITE 120 DALLAS, TX 75214 Ph. (972) 739-0761 Fax. (972) 739-0762</p>	<p>CORPORATE LOGO Z00A BY W-T COMMUNICATIONS GROUP LLC</p>	
<p><b>EROSION HAY BALES</b> 2</p> <p>SCALE: N.T.S.</p> <p><b>CONSTRUCTION NOTES:</b></p> <ol style="list-style-type: none"> <li>1. STRAW BALES SHALL BE PLACED IN A SINGLE ROW AND STAKED WITH MIN 2 STAKES PER BALE GAPS BETWEEN BALES SHALL BE CHINKED WITH STRAW BACKFILL</li> <li>2. OTHER ACCEPTABLE EROSION CONTROL MEASURES ARE THE USE OF BERMS, SEDIMENT BASINS, FILTER NETTING, ETC. AS APPROVED BY MUNICIPAL ENGINEER.</li> <li>3. EROSION CONTROL FEATURES SHALL BE CONTINUOUSLY MAINTAINED UNTIL PERMANENT EROSION CONTROL FEATURES ARE COMPLETED</li> <li>4. IF AFTER REPEATED FAILURE ON THE PART OF THE CONTRACTOR TO PROPERLY CONTROL EROSION, POLLUTION, AND/OR SILTATION, THE MUNICIPALITY RESERVES THE RIGHT TO EFFECT NECESSARY CORRECTIVE MEASURES AND CHARGE ANY COSTS TO THE CONTRACTOR AT STORM DRAIN</li> </ol> <p><b>EROSION FENCE</b> 1</p> <p>SCALE: N.T.S.</p> <p><b>NOTES:</b></p> <ol style="list-style-type: none"> <li>1. SET THE STAKES, MAX 4"</li> <li>2. EXCAVATE A 4" X 4" TRENCH UP ALONG THE LINE OF STAKES</li> <li>3. STAPLE FILTER MATERIAL IT INTO THE TRENCH</li> <li>4. BACKFILL AND COMPACT THE EXCAVATED SOIL</li> </ol> <p><b>NOTES:</b></p> <p>NOTE: ADDITIONAL NOTES &amp; DETAILS SEE STRUCTURAL REPORT.</p> <p>NOTE: BEFORE CUTTING SHELL FOR PENETRATIONS, INSPECT FOR LEAD PAINT AND TAKE APPROPRIATE SAFETY MEASURES. NOTE: CONTRACTOR SHALL SPOT REPAINT TO REPAIR INTERIOR AND EXTERIOR COATINGS DAMAGED AS A RESULT OF THE PROPOSED WORK.</p>		<p><b>STIFFENER DETAIL</b> 3</p> <p>SCALE: N.T.S.</p> <p><b>NOTES:</b></p> <p>NOTE: ADDITIONAL NOTES &amp; DETAILS SEE STRUCTURAL REPORT.</p> <p>NOTICE: PROVIDE WAVESIDE BOOT, CUSHION, CLAMPS AND SEALER</p> <p>SEQUENCE: REBOW TANK CAPACITY 50K OR MORE BEFORE CUTTING SHELL FOR PENETRATORS HELD IN PLACE 12" X 15" BARS CUT HOLE 1: HELD IN PIPE NECK, CUT HOLE 2: HELD IN PIPE NECK.</p>	
<p><b>DRY RISER LADDER TRANSITION</b> 4</p> <p>SCALE: N.T.S.</p> <p><b>NOTES:</b></p> <p>NOTE: CONTRACTOR SHALL CUT LADDER OFF AT SUPPORT STABS AND BUTT KEEN 13/32 X 1/4" EXTENSIONS TO OFFSET LADDER TO 16" FROM DRY RISER SHAFT. NEW LADDER LOCATION TO LINE UP WITH NEW LADDER EXTENSION IN ANTENNA POD.</p> <p>NEW ANTENNA POD TRANSITION NEW 16" X 1/4" TO EXISTING ANGLE RELOCATED ACCESS EXISTING 60° DIA DRY RISER</p>			


IRVING, TEXAS 75039  
SUITE 300  
6030 RIVERSIDE DRIVE




1	05/20/04	FOR CONSTRUCTION
A	05/20/04	PRELIMINARY

**W-T**

W-T COMMUNICATION  
DESIGN GROUP LLC  
3001 FRANCIS SUITE 125  
DALLAS, TEXAS 75214  
ph. (972) 729-0781  
fax. (972) 729-0782

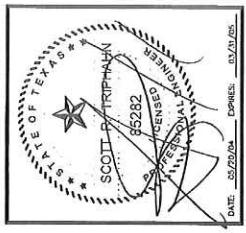


DATE: 05/20/04 EXPIRES: 05/15/05  
SCOTT D. TRIPPLER  
852282  
LICENSED  
PROFESSIONAL  
ENGINEER  
P.E.

PROJECT NO: T04277  
DRAWN BY: TMC  
CHECKED BY: KWM

CASCADE # H058XC335  
LEAGUE CITY  
WATER TOWER  
5123 1/2 CANDLEWOOD  
LEAGUE CITY, TX 77573  
GALVESTON COUNTY

SHEET TITLE  
COAX RUN  
DETAILS


SHEET NUMBER  
**C-8**

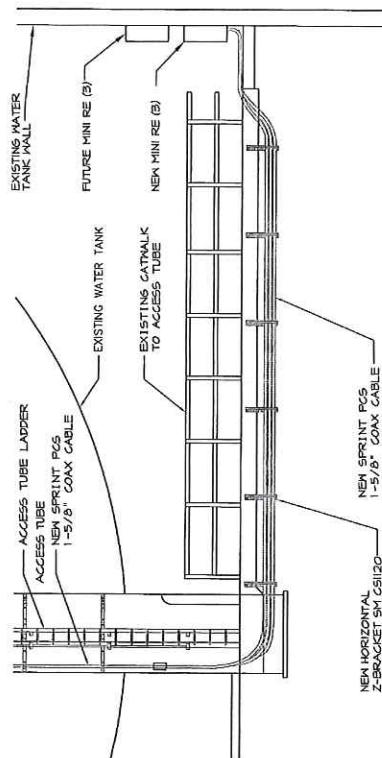

**PROFILE AT TOP PLATFORM**  
SCALE: NTS

**2**

**NOT USED**  
SCALE: NTS

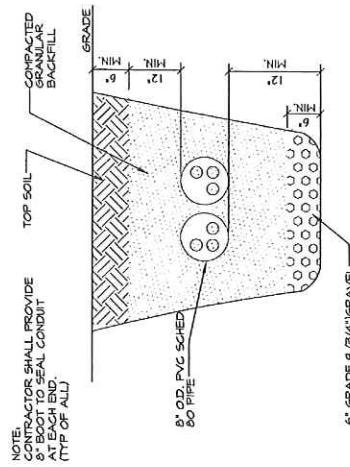

**3**  
**NOT USED**  
SCALE: NTS


**4**  
**CONDUIT TRENCH**  
SCALE: NTS

5030 RIVERSIDE DRIVE  
SUITE 300  
IRVING, TEXAS 75039



**W-T**

W-T COMMUNICATION  
DESIGN GROUP LLC  
201 LA FREDAY SUITE 120  
DALLAS, TEXAS 75234  
PH. (972) 750-0701  
FAX. (972) 750-0702

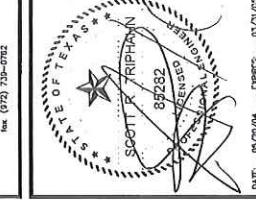

DATE: 09/25/04  
COPR. 2004 BY W-T COMMUNICATION DESIGN GROUP LLC.

PROJECT NO: T04277  
DRAWN BY: TMC  
CHECKED BY: KWM

CASCADE # H05XC35  
LEAGUE CITY  
WATER TOWER  
5123 1/2 CANDLEWOOD  
LEAGUE CITY, TX 77573  
GALVESTON COUNTY

SHEET TITLE  
ELECTRICAL SITE PLAN  
SHEET NUMBER  
**E-1**

NOTE:  
DISCONNECT IS THE  
RESPONSIBILITY OF THE  
CONTRACTOR



**2**

## ELECTRICAL SITE PLAN

SCALE: 1" = 10'-0"

NOTE:  
CONTRACTOR SHALL EXCAVATE TRENCH FOR  
INSTALLATION OF NEW SERVICE UTILITIES AND  
SHALL RESTORE TO ORIGINAL CONDITION

NOTE:  
DISCONNECT IS THE  
RESPONSIBILITY OF THE  
CONTRACTOR


NOTE:  
CONTRACTOR SHALL VERIFY ALL  
LOCATION OF WATERLINES AND  
TO HAND DIG IN THAT AREA

NOTE:  
CONTRACTOR SHALL VERIFY ALL  
UTILITY CONNECTIONS WITH THE  
RESPECTIVE UTILITY COMPANIES  
PRIOR TO INSTALLATION

**1**


## POWER DIAGRAM

33 of 54

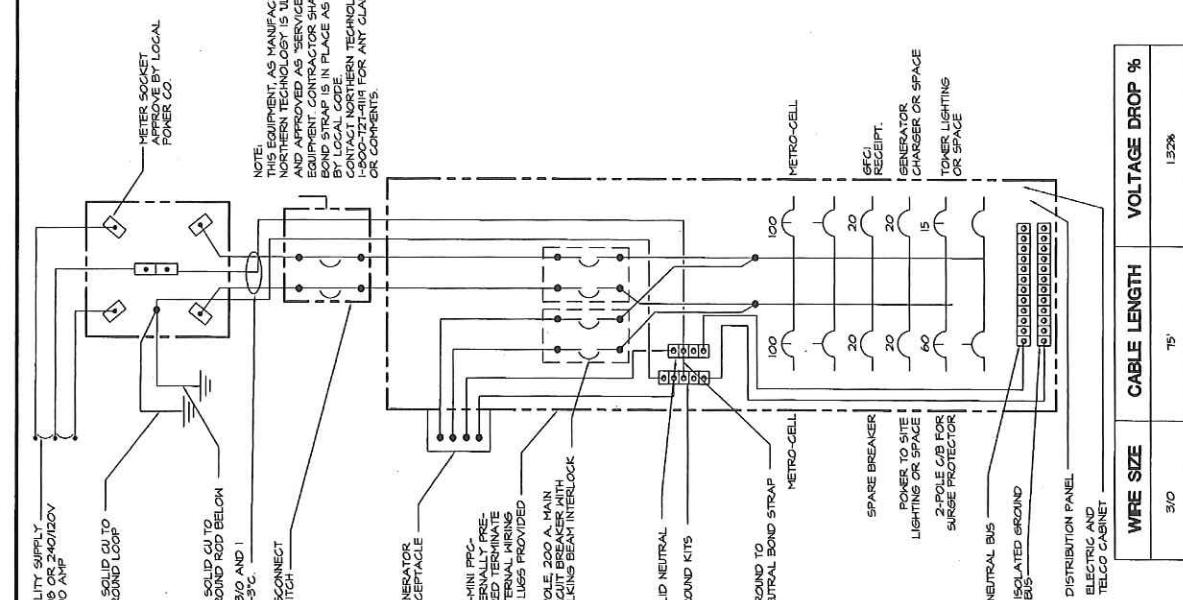


## COORDINATION WITH UTILITY COMPANY

THE ELECTRICAL CONTRACTOR SHALL COORDINATE COMPLETE ELECTRICAL SERVICE WITH LOCAL UTILITY COMPANIES FOR A COMPLETE OPERATIONS SYSTEM. INCLUDES TRANSFORMER CONNECTIONS, CONCRETE TRANSFORMER PADS, PRIOR TO SUBMITTING BID TO INCLUDE ALL LABOR AND MATERIALS.

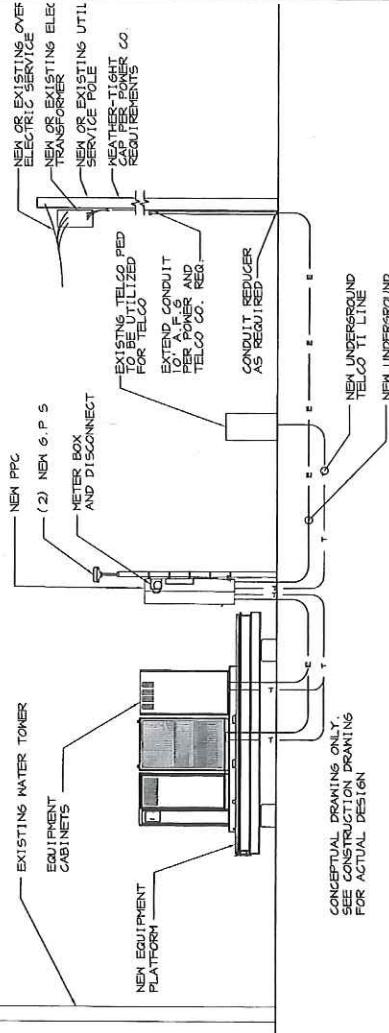

## ELECTRIC AND TELEPHONE RISER 1

SCALE: N.T.S

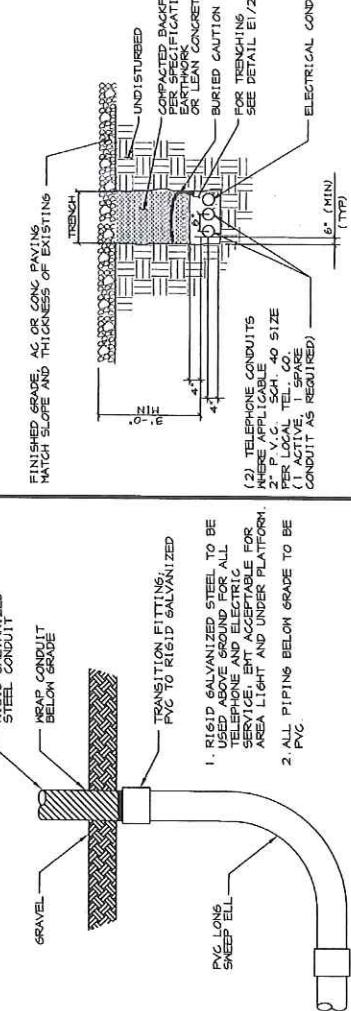

## ELECTRICAL NOTES:

1. ALL ELECTRICAL WORK SHALL BE IN STRICT CONFORMANCE WITH THE NATIONAL ELECTRICAL CODE.
2. ALL ELECTRICAL MATERIALS AND EQUIPMENT SHALL BE U.L. APPROVED.
3. ALL KIRNS SHALL BE COPPER.
4. MINIMUM KIRE SIZE SHALL BE # 12 AWG.
5. ALL CONDUCTORS SHALL BE IDENTIFIED AT ALL CONNECTIONS, JUNCTION BOXES AND FITTINGS.
6. COORDINATE LOCATION AND POWER REQUIREMENTS OF ALL EQUIPMENT WITH EQUIPMENT SUPPLIERS PRIOR TO INSTALLATION.
7. ALL POWER KIRNS SHALL BE TYPE "THHN" RATED 40° C.
8. TWO ELOOD LIGHT CIRCUITS SHALL BE (2) #12 AND #12 AND IN MINIMUM 3/4" CONDUIT. CONDUIT SHALL BE RIGID CONDUIT ABOVE GRADE OR PVC CONDUIT GRADE CONNECT BOTH LIGHTS ON SAME 20A CIRCUIT IN PVC CONDUIT. CONDUIT SHALL BE RUN UNDER EQUIPMENT PLATFORM OR UNDERGROUND IF IT MAY BE A TRIPPING HAZARD.
9. CONTRACTOR TO OBTAIN ALL PERMITS, PAY PERMIT FEES, AND BE RESPONSIBLE FOR SCHEDULING INSPECTIONS.
10. CONTRACTOR TO OBTAIN LOCAL POWER AND TELEPHONE COMPANY APPROVAL AND COORDINATE WITH LOCAL UTILITIES SERVICE ENTRANCE REQUIREMENTS.
11. PROVIDE ALL LABOR AND MATERIAL DESCRIBED ON THIS DRAWING, AND ALL ITEMS INCIDENTAL TO COMPLETING AND PRESENTING THIS PROJECT AS FULLY ASSEMBLED.
12. CONTRACTOR TO PROVIDE TELEPHONE CONDUIT AS SHOWN ON PLANS.
13. CONTRACTOR TO PROVIDE ELECTRIC CONDUIT AS SHOWN ON PLANS.
14. NOTIFY LOCAL UTILITY SERVICE PRIOR TO ANY INSTALLATION.
15. ALL EQUIPMENT FURNISHED BY OTHERS SHALL BE PROVIDED WITH PROPER MOTOR STARTERS, DISCONNECTS, CONTROLS, ETC. BY THE ELECTRICAL CONTRACTOR UNLESS SPECIFICALLY NOTED OTHERWISE. THE ELECTRICAL CONTRACTOR SHALL INSTALL AND COMPLETELY WIRE ALL ASSOCIATED EQUIPMENT IN ACCORDANCE WITH MANUFACTURER'S WIRE DIAGRAMS AND AS REQUIRED FOR A COMPLETE OPERATING INSTALLATION. ELECTRICAL CONTRACTOR SHALL COORDINATE ELECTRICAL CHARACTERISTICS AND REQUIREMENTS OF EQUIPMENT PRIOR TO BIDDING IN CONDUIT AND KIRNS TO AVOID CONFLICTS.
16. UTILITY COMPANY COORDINATION.

ELECTRICAL CONTRACTOR SHALL CONFIRM THAT ALL WORK IS IN ACCORDANCE WITH THE RULES OF THE LOCAL UTILITY COMPANY BEFORE SUBMITTING HIS BID. THE CONTRACTOR SHALL CHECK WITH THE UTILITY COMPANIES SUPPLYING SERVICE TO THIS PROJECT AND SHALL DETERMINE FROM THEM ALL EQUIPMENT AND CHARGES WHICH THEY WILL REQUIRE AND SHALL INCLUDE THE COST IN HIS BID.

## CONDUITS AND WIRING:

1. KIRNS OF EVERY KIND MUST BE INSTALLED IN CONDUIT, UNLESS NOTED OTHERWISE, OR AS APPROVED BY THE ENGINEER.
2. KIRNS AND CABLES FOR POWER SHALL BE INSTALLED IN GALVANIZED RIGID STEEL CONDUIT OR FLEXIBLE LIQUID TIGHT CONDUIT AS INDICATED ON DRAWING.
3. RACENAYS SHALL BE GALVANIZED STEEL, SIZED IN ACCORDANCE WITH THE NATIONAL ELECTRICAL CODE, UNLESS OTHERWISE NOTED. ALL RACENAYS SHALL BE APPROVED FOR THE INSTALLATION.
4. RULL OR JUNCTION BOXES SHALL BE PROVIDED AS REQUIRED TO FACILITATE INSTALLATION OF RACENAYS AND KIRNS.
5. PROVIDE A COMPLETE RACENAY AND KIRNS INSTALLATION, PERMANENTLY AND EFFECTIVELY GROUNDED IN ACCORDANCE WITH ARTICLE 250 OF THE NATIONAL ELECTRICAL CODE AND LOCAL CODES.
6. CONTRACTOR SHALL INSTALL CONDUIT AND KIRE TO THE EQUIPMENT, COIL KIRE, SEAL TERMINATE AT EQUIPMENT (MINIMUM OF 10 FEET).
7. CONDUIT ENTRIES INTO OUTDOOR EQUIPMENT SHALL BE FROM BOTTOM.

## ELEC/TELCO TRENCH 3

SCALE: N.T.S

## CONDUT DETAILED 2

SCALE: N.T.S

SHEET TITLE  
ELECTRICAL CO. RISER  
AND DETAILS  
**E-2**

SHEET NUMBER  
**E-2**

## GROUNDING NOTES:

1. GROUNDING CONNECTIONS SHALL BE EXOTHERMIC KELDS TO ANTENNA MASTS AND THE GROUND BARS. REMAINING GROUNDING CONNECTIONS SHALL BE COMPRESSION FITTINGS.
2. GROUND CONNECTIONS TO EQUIPMENT SHALL BE MADE USING TWO-HOLE CONNECTIONS PROVIDED STAINLESS STEEL BOLTS AND LOCK WASHERS ON ALL MECHANICAL GROUND CONDUCTORS (USE LONG-BARREL LUG TYPE OR EQUIVALENT).
3. EQUIPMENT SURFACES TO BE BONDED TO GROUNDING SYSTEM SHALL BE STRIPPED OF ALL PAINT AND DIRT.
4. EXTERIOR GROUND CONNECTIONS SHALL BE FURNISHED WITH A LIBERAL PROTECTIVE COATING OF ANTI-OXIDE COMPOUND.
5. ALL EXOTHERMIC KELDS SHALL BE CADHELD OR APPROVED EQUAL.
6. ALL CABLE TRAY AND WAVEGUIDE SECTIONS TO BE GROUNDED TOGETHER BY JUMPERS, BOND EACH SECTION OF CABLE TRAY AND WAVEGUIDE TO THE GROUNDING CONDUCTOR WITH JUMPERS.
7. GROUNDING CONDUCTOR SHALL BE BURIED 30° BELOW GRADE UNTIL AN ABOVE GRADE CONNECTION IS MADE.
8. GROUND BAR SHALL BE NENTON INSTRUMENT CAT. 19081-4 OR EQUAL. MOUNTINGS BRACKETS SHALL BE NENTON INSTRUMENT CAT. A-6056 OR EQUAL.
9. GROUND BAR SHALL BE MOUNTED VERTICALLY WHERE POSSIBLE.
10. ADD LABEL "DO NOT REMOVE GROUND LEADS" AT EACH GROUND BAR.
11. INSTALL ALL ABOVE GRADE GROUND LEADS IN NONMETALLIC FLEXIBLE CONDUIT.
12. GROUNDING SHALL COMPLY WITH ARTICLE 250 OF THE NATIONAL ELECTRICAL CODE.
13. GROUND COAXIAL CABLE SHIELDS AT BOTH ENDS WITH COAX CABLE GROUNDS KITS AND INSTALL GROUND KIT AT EACH CONNECTION.
14. ROUTE GROUNDING CONDUCTORS ALONG THE SHORTEST AND STRAIGHTEST PATH POSSIBLE, EXCEPT AS OTHERWISE INDICATED. GROUNDING LEADS SHOULD NEVER BE BENT AT RIGHT ANGLE; ALWAYS HAVE AT LEAST 12" RADIUS BENDS #6 WIRE CAN BE BENT AT 8" RADIUS WHEN NECESSARY.
15. CONTRACTOR TO PROVIDE GROUND RING, AS SHOWN ON GROUNDING SITE PLAN AND GROUNDING RISER DIAGRAM. CONTRACTOR SHALL TEST AND VERIFY THAT THE IMPEDANCE DOES NOT EXCEED 5 OHMS TO GROUND BY MEANS OF A BIDDLE-MESGER TESTER. GROUNDINGS AND OTHER OPERATIONAL TESTING SHALL BE ARRANGED BY THE OWNERS, REPRESENTATIVE.
16. GROUNDING CONDUCTORS SHALL BE COPPER ONLY, ABOVE GROUND, EITHER SOLID OR BIPOLAR. GROUNDING CONDUCTORS SHALL BE EXTERIOR CONDUCTORS WITH THE EXCEPION FOR GROUNDING RISER, WHICH MAY BE INSULATED. BIG TOTM AND ANEN TOWER MUST BE BARE. EQUIPMENT GROUND LEADS IN CABINETS MUST BE GREEN INSULATED.
17. ALL EXOTHERMIC KELDS ABOVE FINISHED GRADE SHALL BE PAINTED WITH COLD GALVANIZED ZINC ENRICHED PAINT TO MATCH COLOR OBJECT BONDED TO IT.
18. THE FENCE GATE JUMPER SHALL BE A 4/0 WELDING CABLE OR A FLEXIBLE 1 INCH COPPER BRAIDED JUMPER WITH SLEEVES ON EACH END DESIGNED FOR EXOTHERMIC WELDING.




IRVING, TEXAS 75039  
5030 RIVERSIDE DRIVE SUITE 300

**W-T**

W-T COMMUNICATION  
DESIGN GROUP LLC

3001 LA FRENO, SUITE 122  
DALIAS, TX 75234  
ph. (972) 755-0711  
fax (972) 755-0712

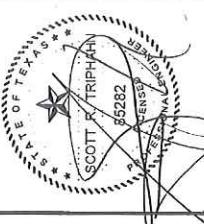

DATE: 05/20/04 DRAWN: 05/21/04

PROJECT NO: 704277

DRAWN BY: TMC

CHECKED BY: KWM


CASCADE # HOBXC335  
LEAGUE CITY  
WATER TOWER  
5123 1/2 CANDLEWOOD  
LEAGUE CITY, TX 77573  
GALVESTON COUNTY

SHEET TITLE  
GROUNDING PLAN

SHEET NUMBER  
**G-1**

**GROUNDING PLAN**

1

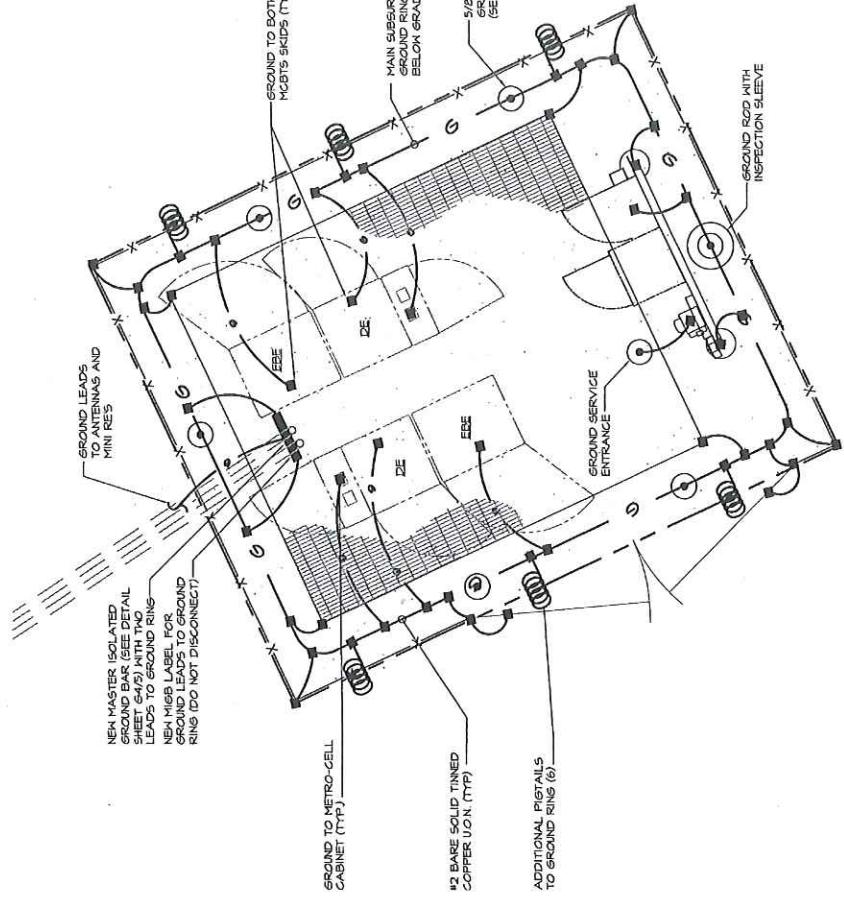

SCALE: 1/4" = 1'-0"

05/21/04


NORTH



**W-T**

W-T COMMUNICATION  
DESIGN GROUP LLC

301 LBJ FREWAY, SUITE 120  
DALLAS, TEXAS 75234  
Ph. (972) 733-5701  
Fax. (972) 733-5702

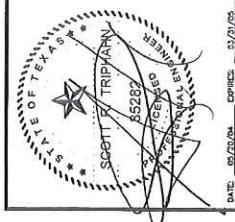

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PROJECT NO: T04277


DRAWN BY: TMIC

CHECKED BY: KWM

CASCADE # H05XCC35  
LEAGUE CITY  
WATER TOWER  
5123 1/2 CANDLEWOOD  
LEAGUE CITY, TX 77573  
GALVESTON COUNTY

SHEET TITLE  
GROUNDING  
RISER  
DIAGRAM

SHEET NUMBER  
**G-2**

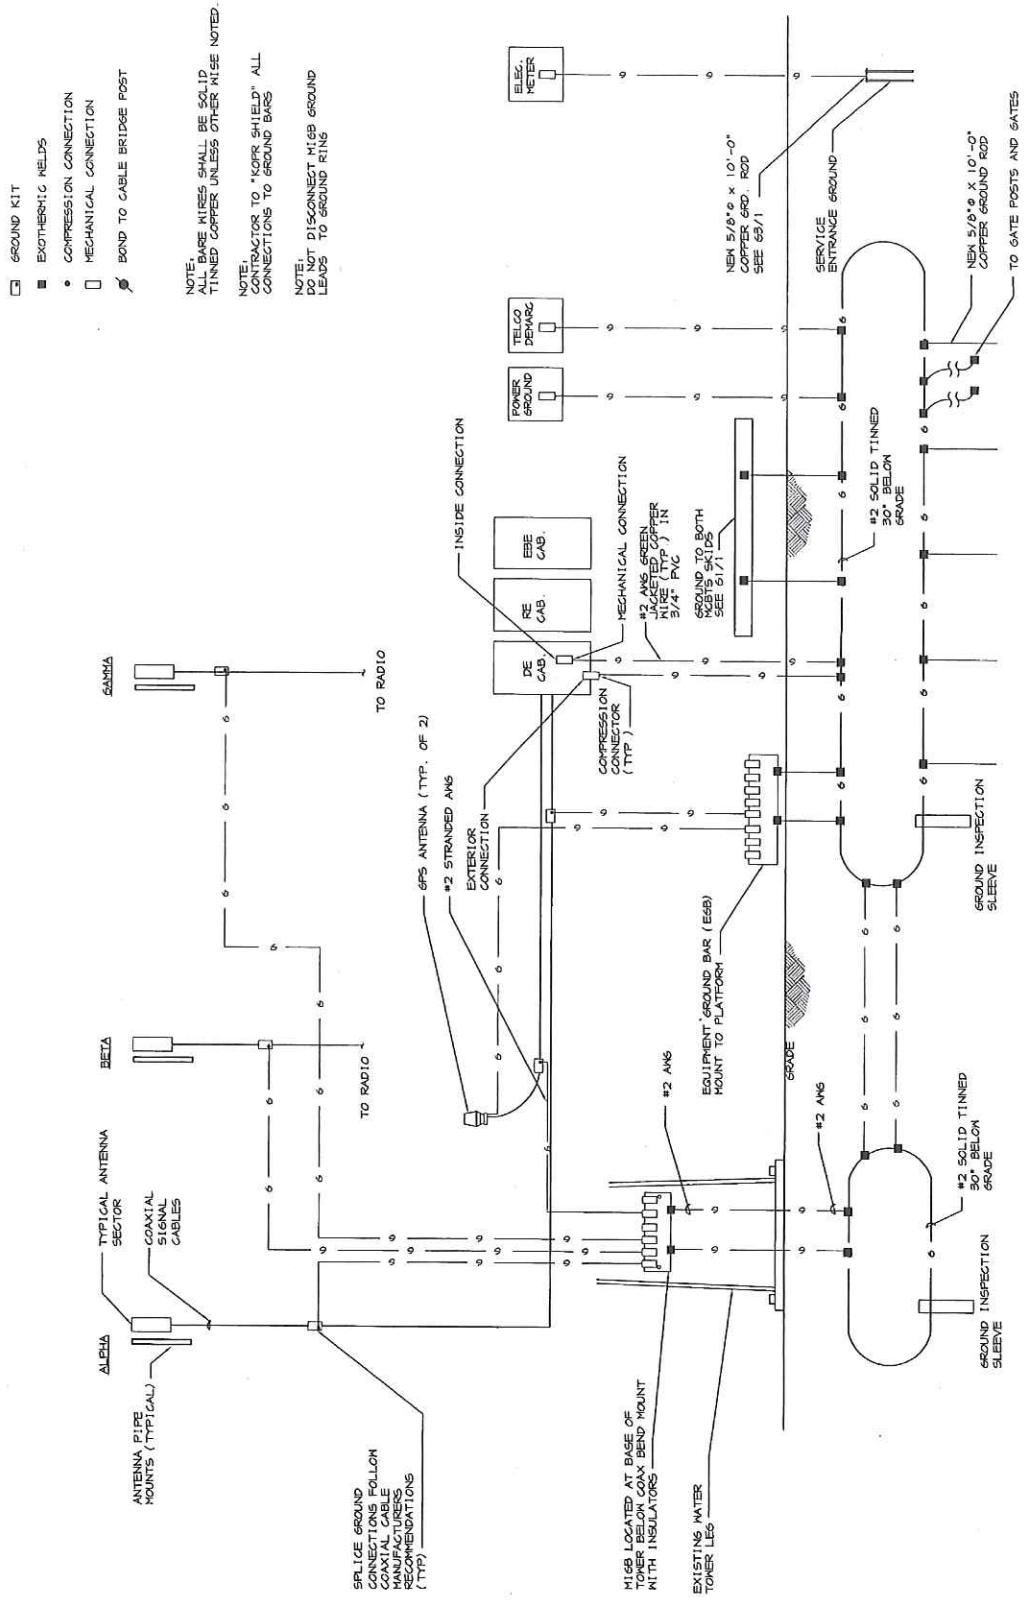

**GROUNDING  
RISER DIAGRAM**


SCALE: NTS

5030 RIVERSIDE DRIVE  
SUITE 300  
IRVING, TEXAS 75039




W-T COMMUNICATION GROUP LLC  
3001 LBJ FREEWAY, SUITE 300  
DALLAS, TEXAS 75234  
PH: (972) 735-0701  
FAX: (972) 735-0702

SHEET NUMBER  
**G-3**

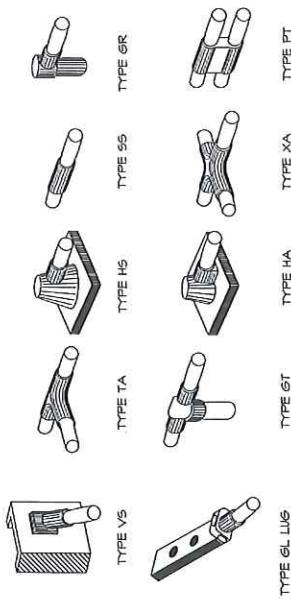


NOTE: CADWELD "TYPES" SHOWN ABOVE ARE EXAMPLES  
CONSULT WITH PROJECT MANAGER FOR SPECIFIC  
TYPES OF CADWELDS TO BE USED FOR THIS PROJECT.

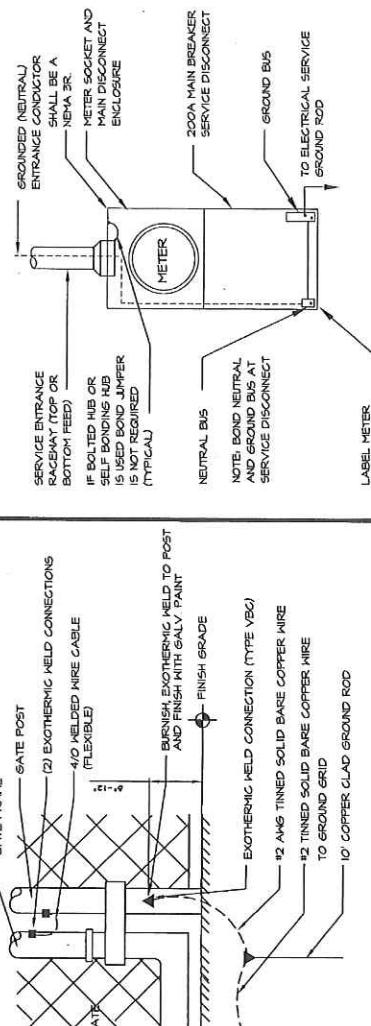


**GATE GROUNDING DETAIL** 1  
SCALE: N.T.S.

**SERVICE ENTRANCE GROUNDING** 2  
SCALE: N.T.S.

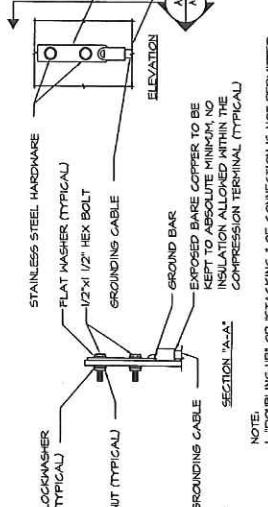


NOTE:  
1. "DOUBLING UP" OR "STACKING" OF CONNECTION IS NOT PERMITTED.  
2. OXIDE INHIBITING COMPOUND TO BE USED AT ALL LOCATIONS.

**TYPICAL GROUND BAR  
CONNECTIONS DETAIL** 4  
SCALE: N.T.S.

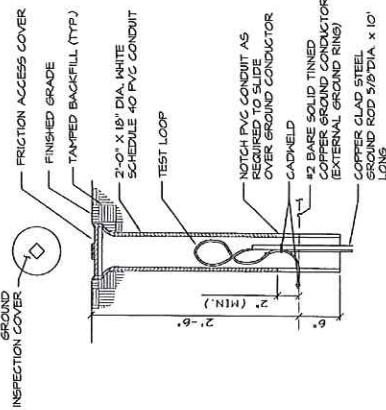

**INSPECTION WELL DETAIL** 5  
SCALE: N.T.S.

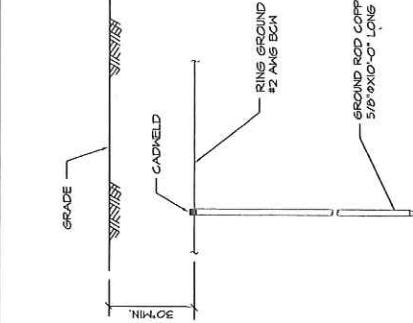

**CADWELD TYPES**  
SCALE: N.T.S.

**(3)**

\* \* \* STATE OF TEXAS \* \* \*  
SCOTT R. TRIPPIAN  
DESIGN GROUP LLC  
3001 LBJ FREEWAY, SUITE 300  
DALLAS, TEXAS 75234  
PH: (972) 735-0701  
FAX: (972) 735-0702

DATE: 05/02/04

1. 05/02/04 FOR CONSTRUCTION  
1. 05/02/04 FEBULAR

CASCADE # HOS5XC35  
LEAGUE CITY  
WATER TOWER  
5123 1/2 CANDLEWOOD  
LEAGUE CITY, TX 77573  
GALVESTON COUNTY

SITE GROUNING  
DETAILS

SHEET NUMBER  
**G-3**

**GROUND ROD**  
SCALE: N.T.S.

**(6)**

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**(5)**

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**(4)**




5030 RIVERSIDE DRIVE  
SUITE 300  
IRVING, TEXAS 75039

**W-T**

W-T COMMUNICATION DESIGN GROUP LLC

2021 LBJ FREeway, SUITE 120  
DALLAS, TEXAS 75234  
Ph. (972) 739-2701  
Fax. (972) 739-5972

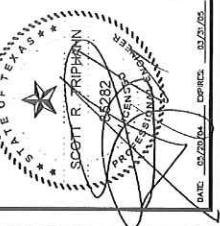


PROJECT NO: 704277  
DRAWN BY: TMC  
CHECKED BY: KWM


CASCADE # H08XC335  
LEAGUE CITY  
WATER TOWER  
5123 1/2 CANDLEWOOD  
LEAGUE CITY, TX 77573  
GALVESTON COUNTY

SHEET TITLE  
COAX CABLE  
GROUNDING DETAILS  
SHEET NUMBER  
**G-4**

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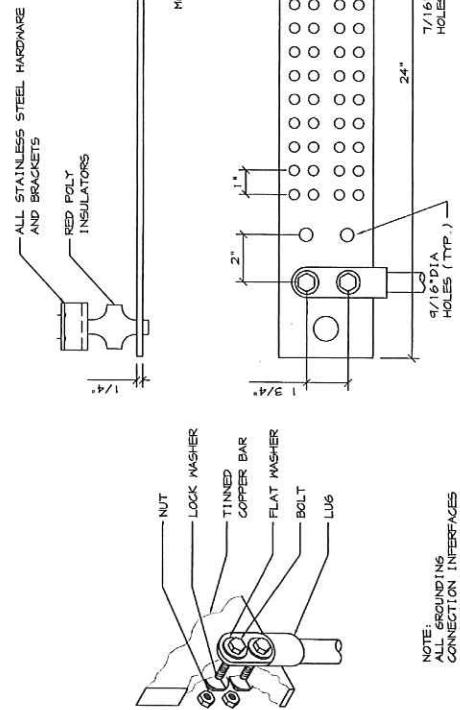


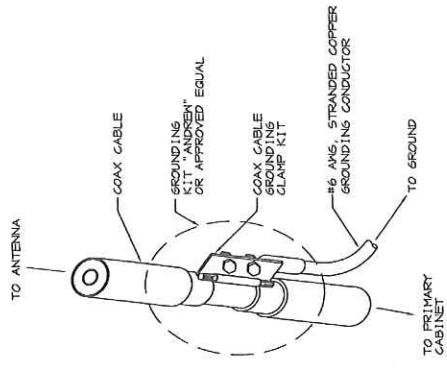**COAX CABLE GROUNDING DETAIL** 3  
SCALE: N.T.S.

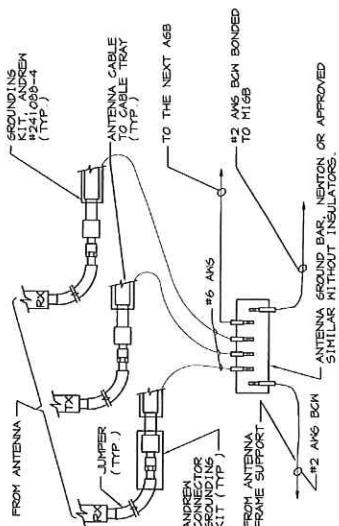

**GROUND WIRE CONNECTION TO GROUND BAR AT 3 ANTENNAS** 2  
SCALE: N.T.S.

**NOT USED**  
SCALE: N.T.S.




**GROUND BAR DETAIL** 5  
SCALE: N.T.S.

**NOT USED**  
SCALE: N.T.S.

5030 RIVERSIDE DRIVE  
SUITE 300  
IRVING, TEXAS 75039




W-T  
COMMUNICATION  
DESIGN GROUP LLC  
3001 LP MICHAN, SUITE 120  
DALLAS, TEXAS 75254  
(972) 753-0701  
(972) 753-0702

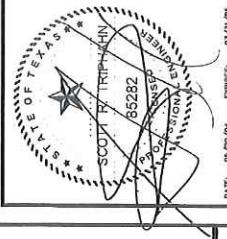

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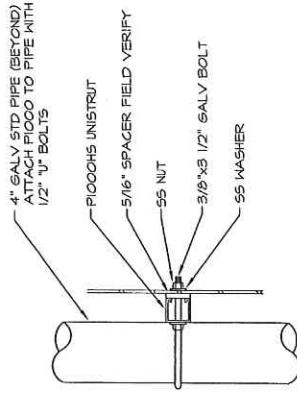
D-1

PLATINUM DESIGN AND DETAILS  
(PRINTED BY OTHERS)

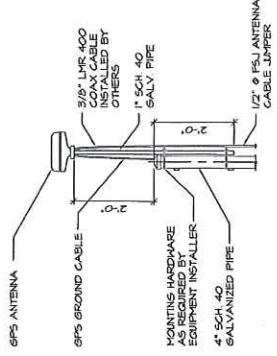


**GPS ANTENNA  
MOUNTING DETAIL** 3

SCALE: N.T.S.




**UTILITY FRAME-MOUNTING DETAIL** 5

SCALE: 1/2" = 1'-0"

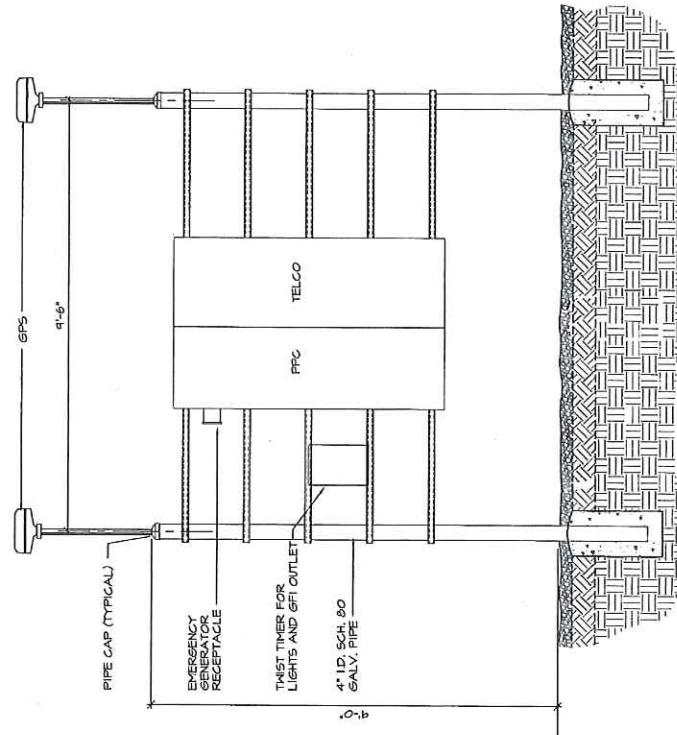


**UTILITY FRAME ELEVATION (FRONT)** 2

SCALE: 3/8" = 1'-0"

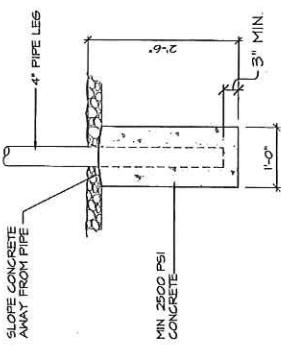


**UTILITY FRAME-PIER DETAIL** 4

SCALE: 1/2" = 1'-0"

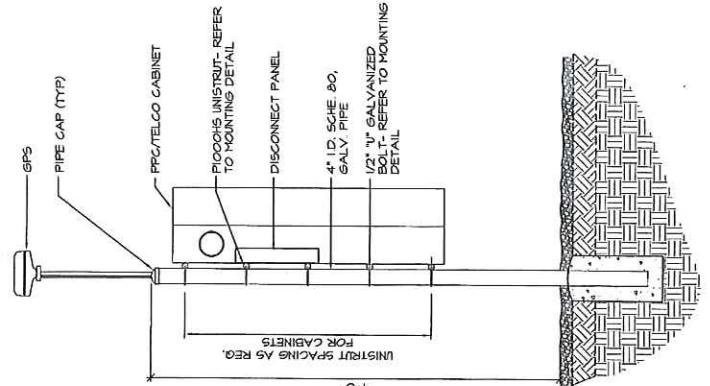


**UTILITY FRAME ELEVATION (SIDE)** 1

SCALE: 3/8" = 1'-0"

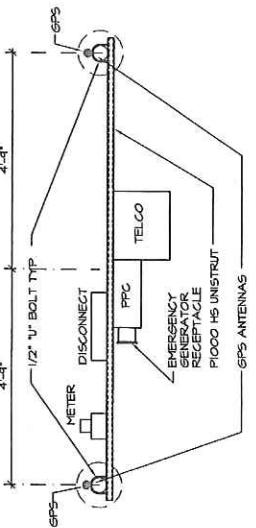


**UTILITY FRAME PLAN** 3

SCALE: 3/8" = 1'-0"

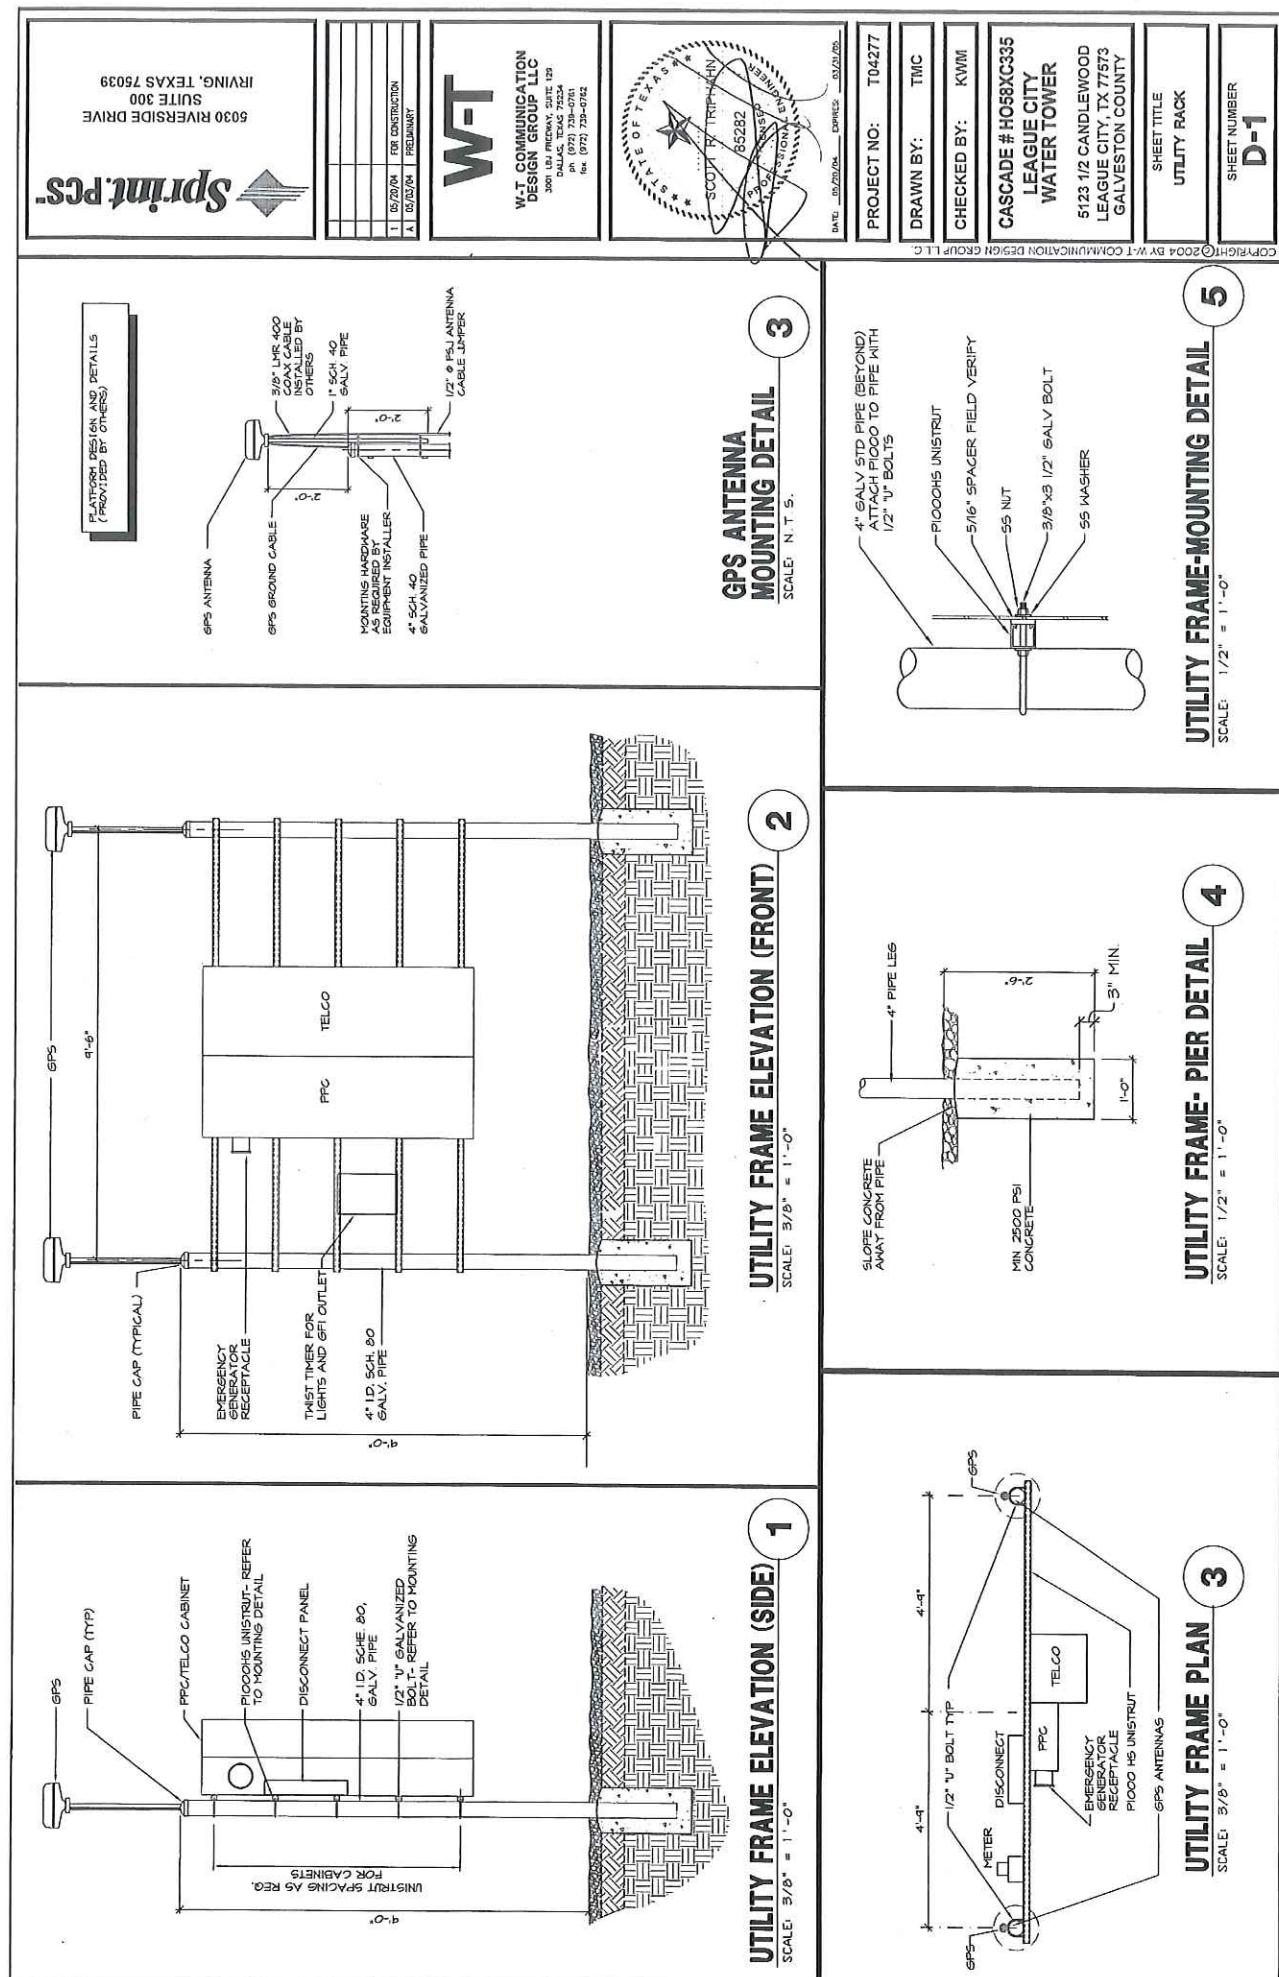


5030 RIVERSIDE DRIVE  
SUITE 300  
IRVING, TEXAS 75039

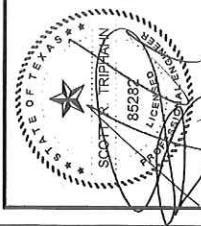


COPIRIGHT © 2004 BY W-T COMMUNICATION DESIGN GROUP LLC

PROJECT NO:	TD4277
DRAWN BY:	TMC
CHECKED BY:	KMM
CASCADE # H05XCC35 LEAGUE CITY WATER TOWER 5123 1/2 CANDLEWOOD LEAGUE CITY, TX 77573 GALVESTON COUNTY	
SHEET TITLE:	SKD MOUNT LAYOUT
SHEET NUMBER:	D=2

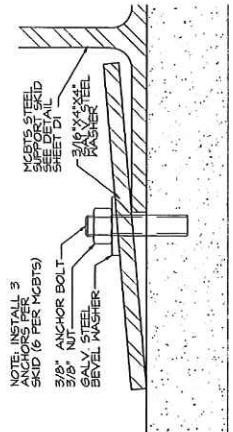


### ANCHOR DETAIL 2

SCALE: N.T.S.

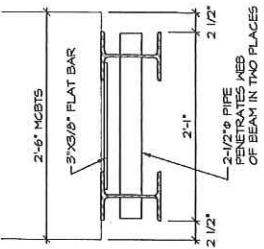


**4**  
END VIEW  
SCALE: 3/4" = 1'-0"

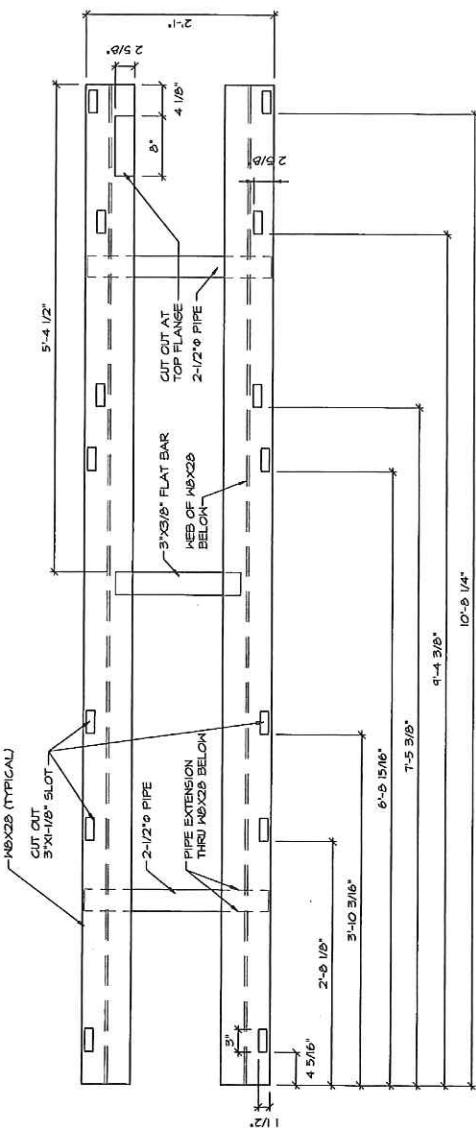


### TOP VIEW 1

SCALE: 3/4" = 1'-0"

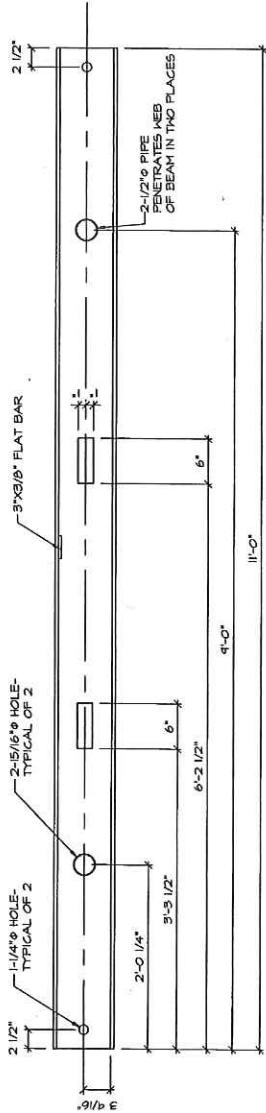

**3**  
SECTION  
SCALE: 3/4" = 1'-0"

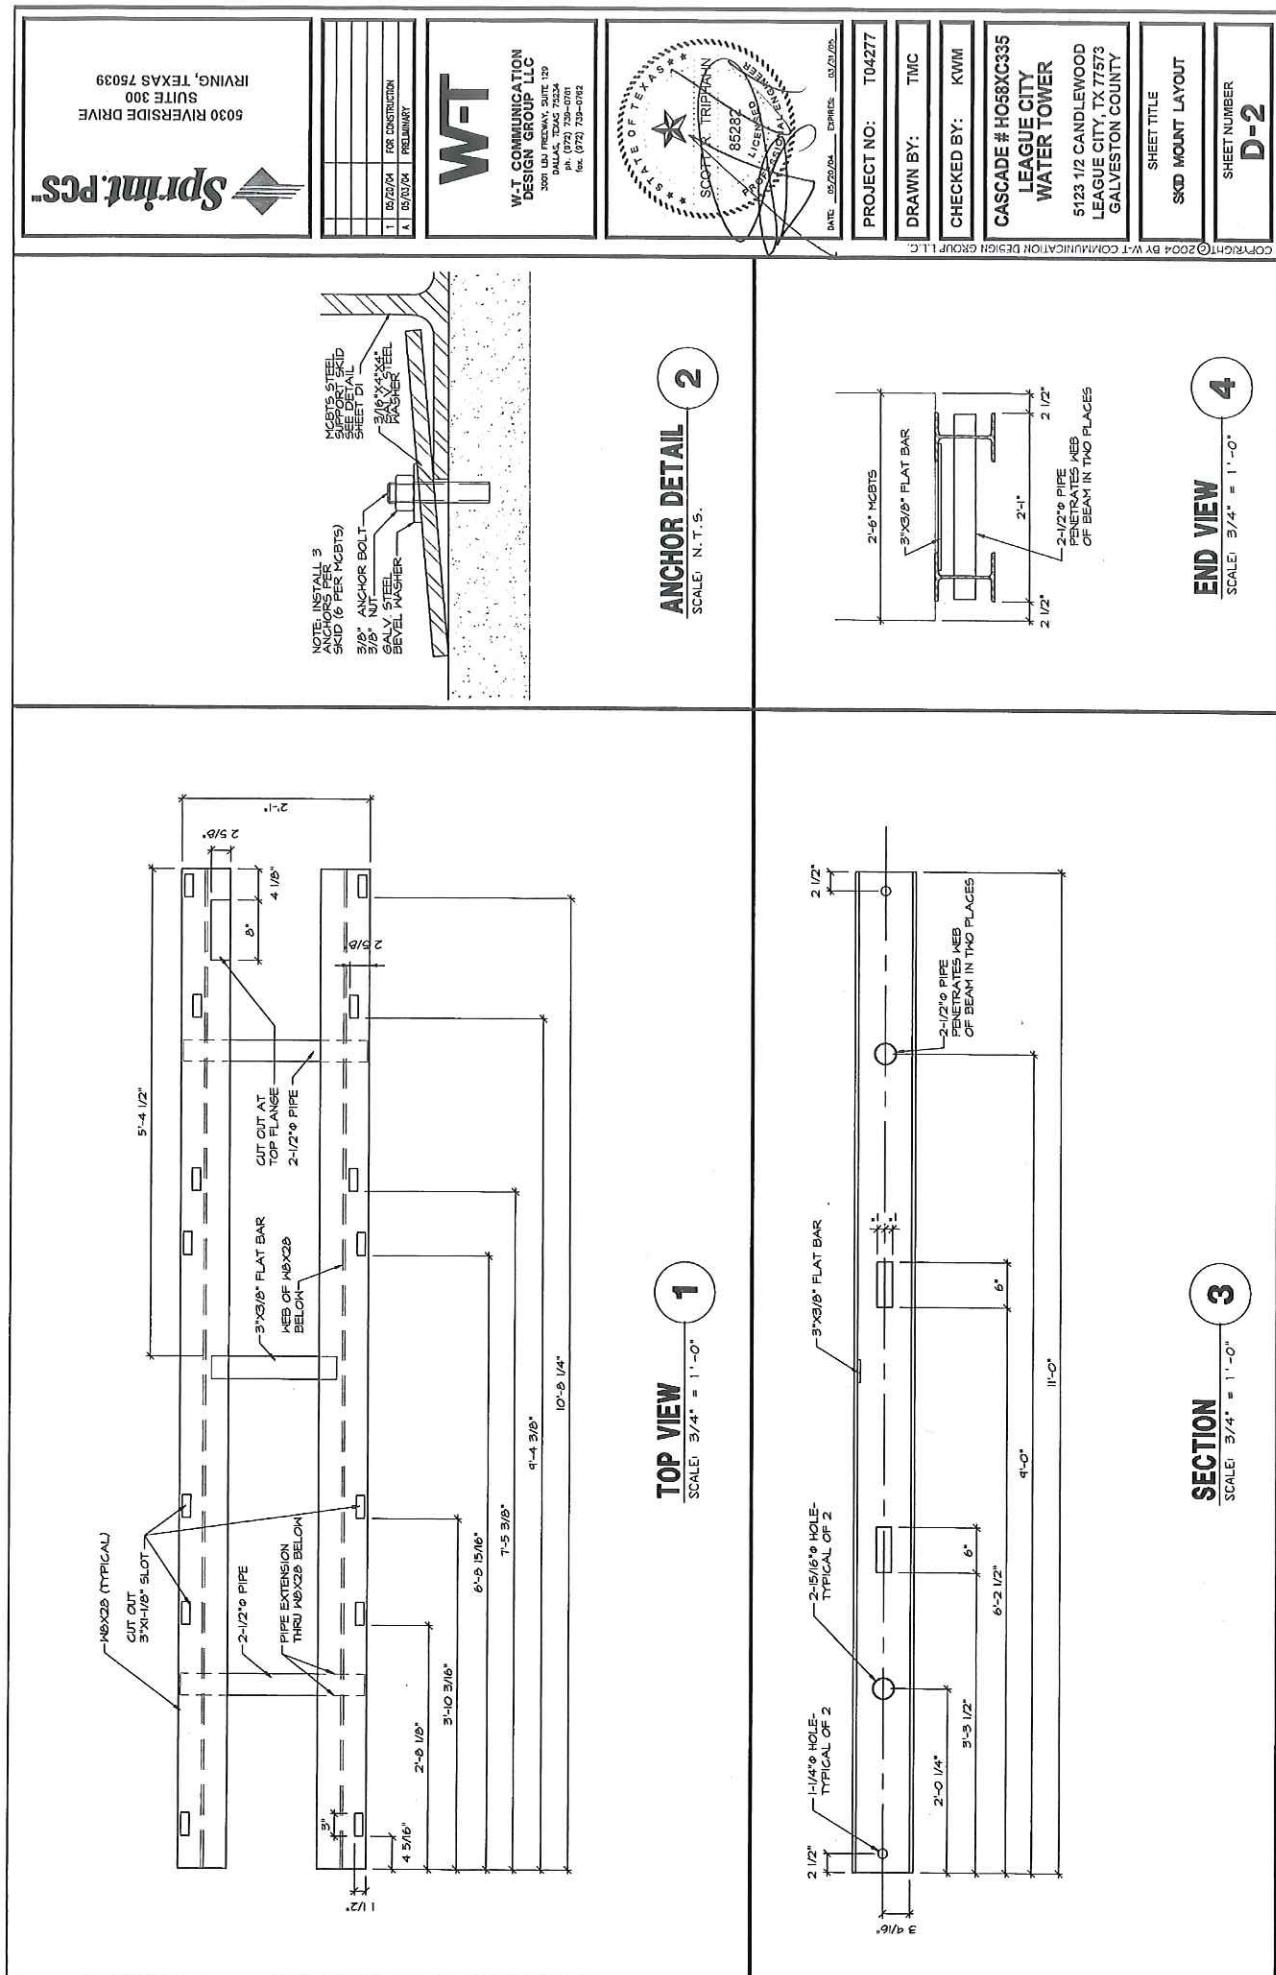


IRVING, TEXAS 75039  
5030 RIVERSIDE DRIVE SUITE 300



W-T  
COMMUNICATION  
DESIGN GROUP LLC

SONG LYRICWAY, SUITE 120  
DALLAS, TEXAS 75234  
PH: (972) 738-0701  
FAX: (972) 738-0702

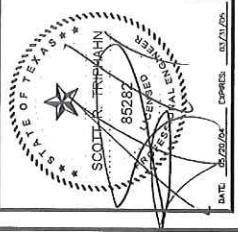


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PROJECT NO.: T04277  
DRAWN BY: TMC  
CHECKED BY: KMM

## ANCHOR BOLT PLACEMENT


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SCALE: 3/4" = 1'-0"


## PLATFORM LAYOUT

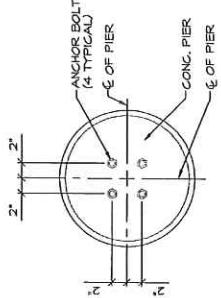
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PLATFORM DESIGN AND DETAILS  
(PROVIDED BY OTHERS)



SHEET NUMBER  
**D-3**



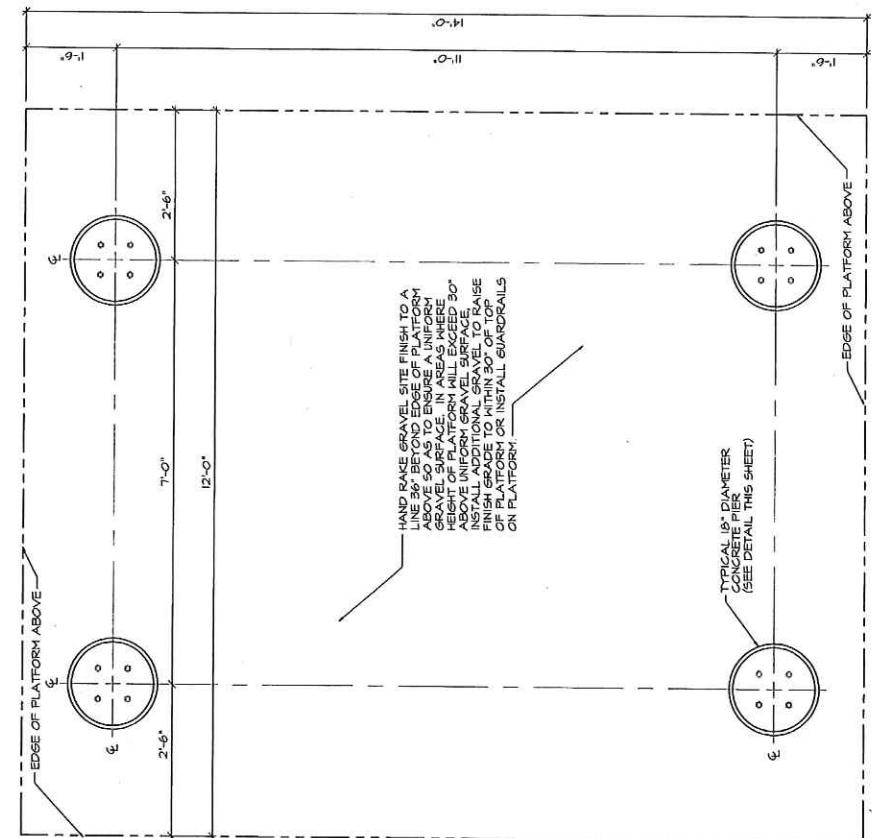


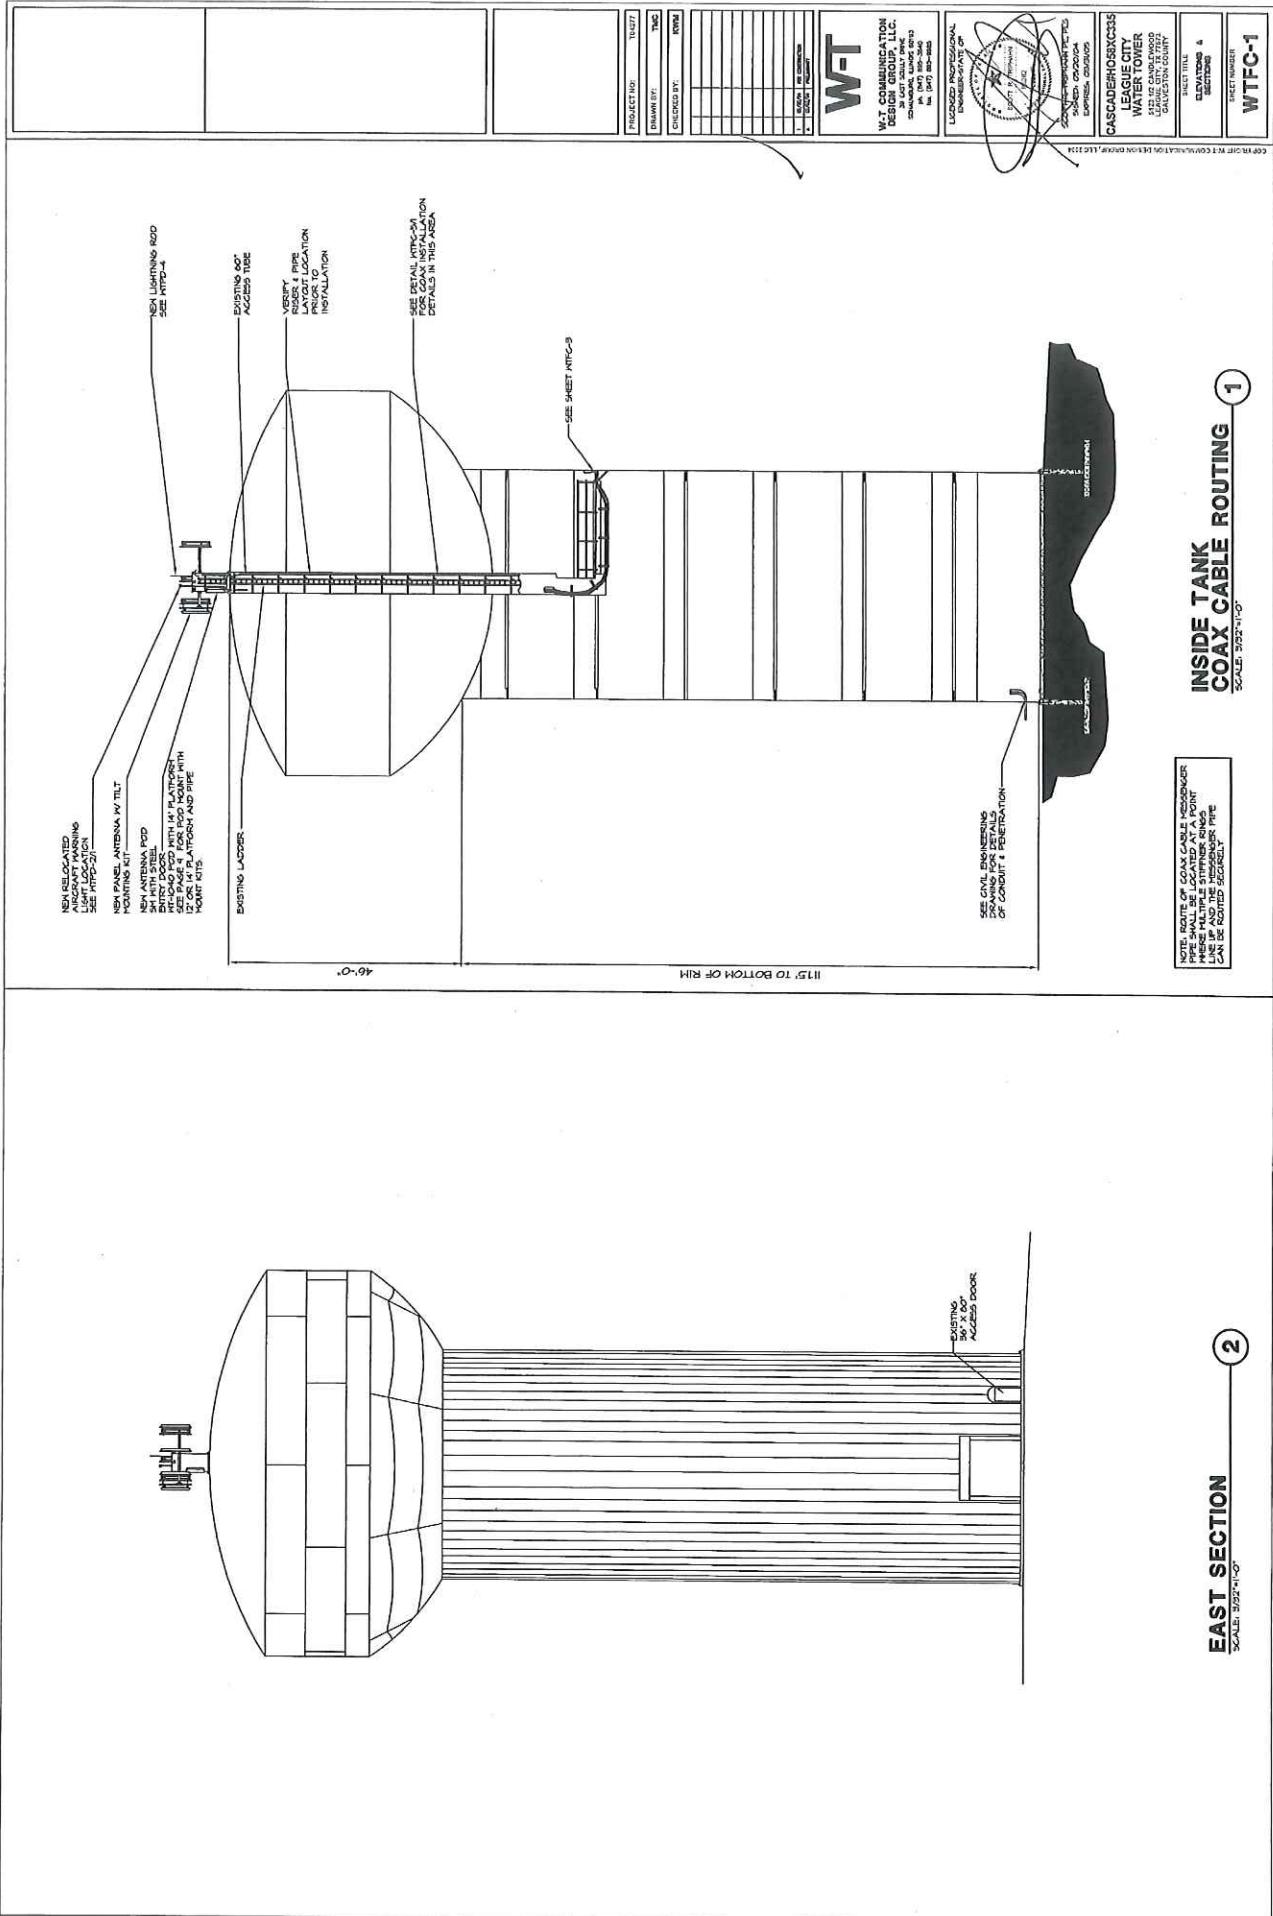POD ATTACHMENT ELEVATION 1

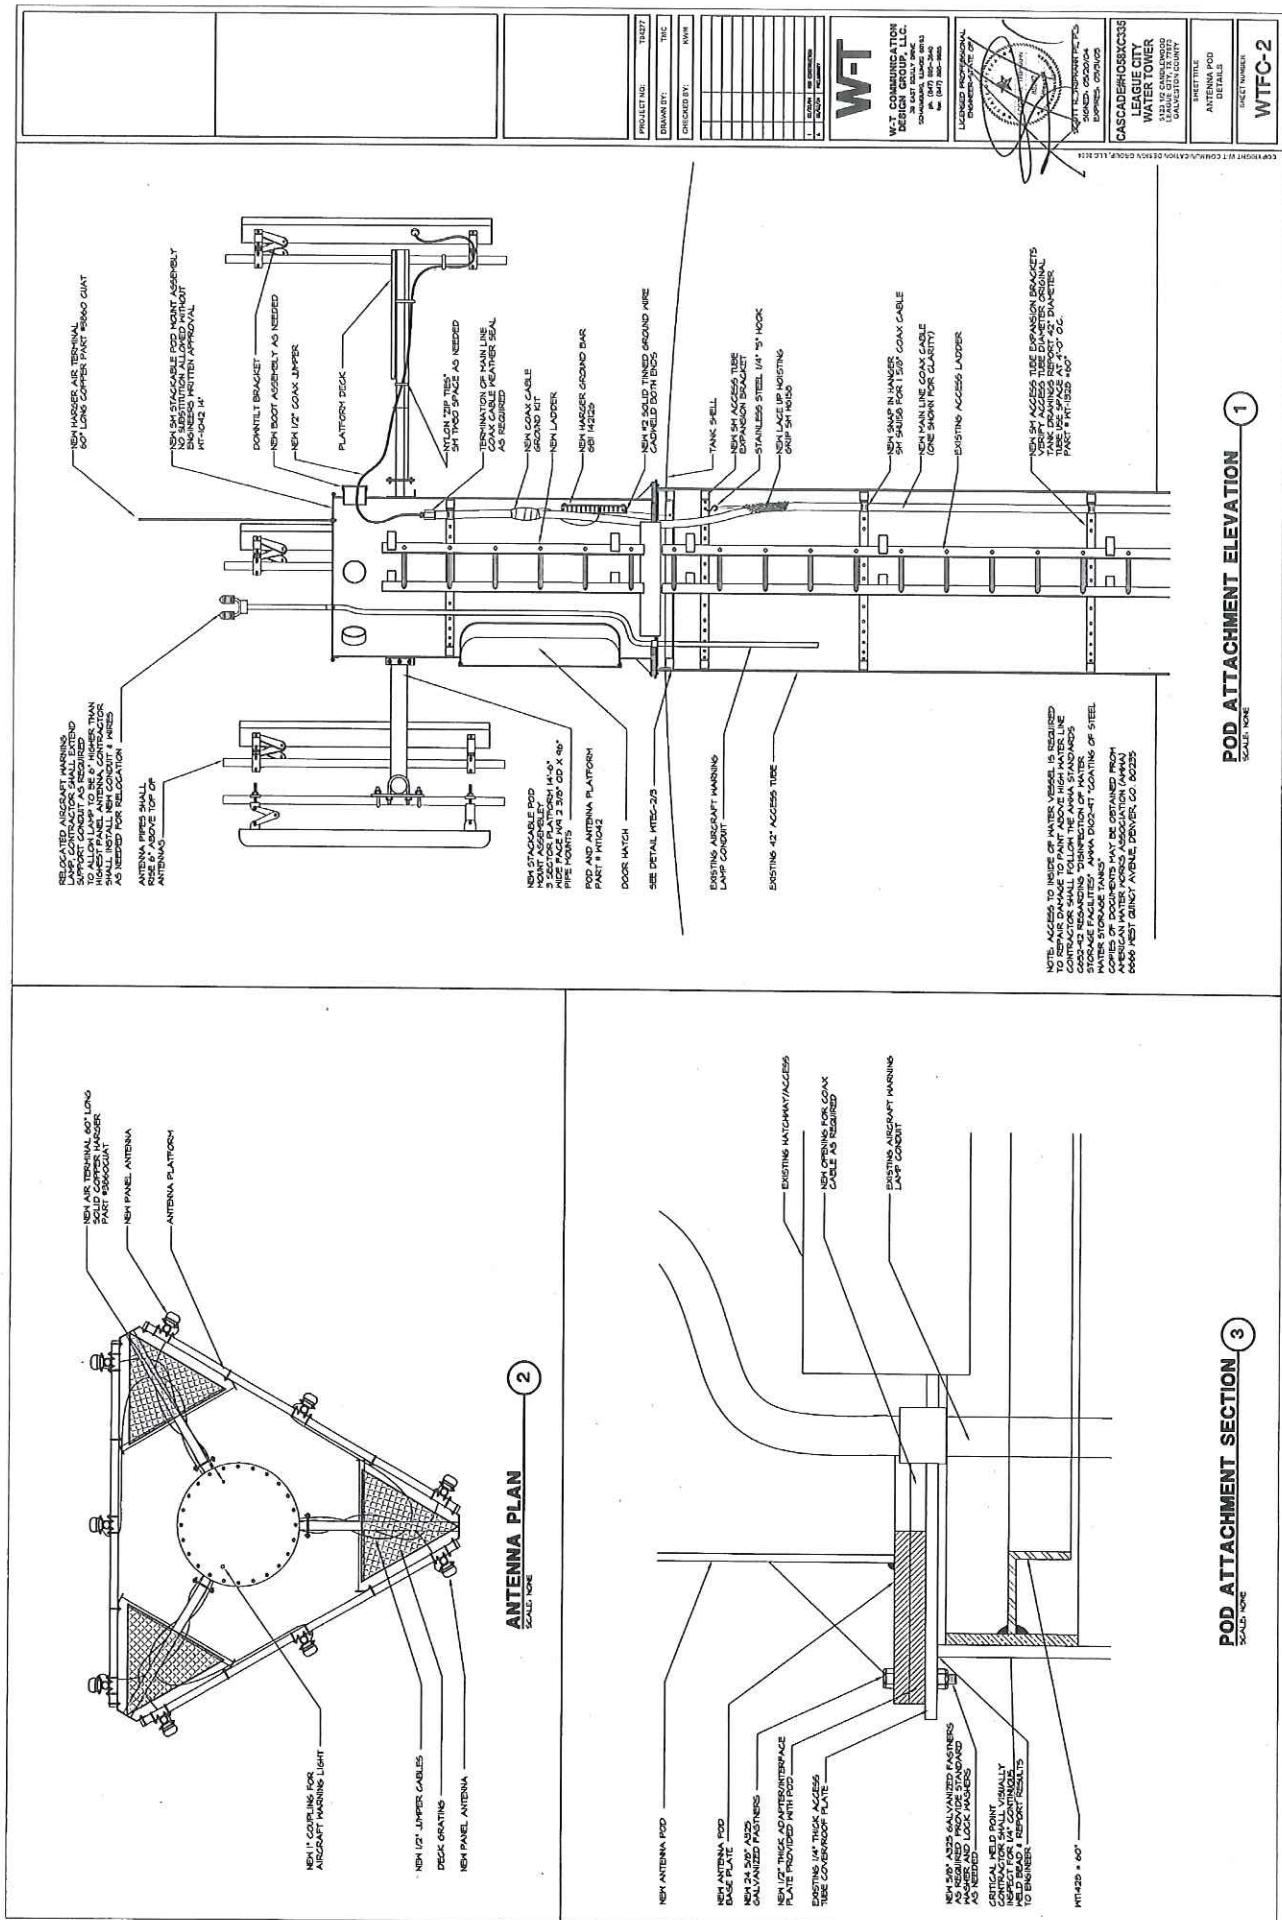POD ATTACHMENT SECTION 3

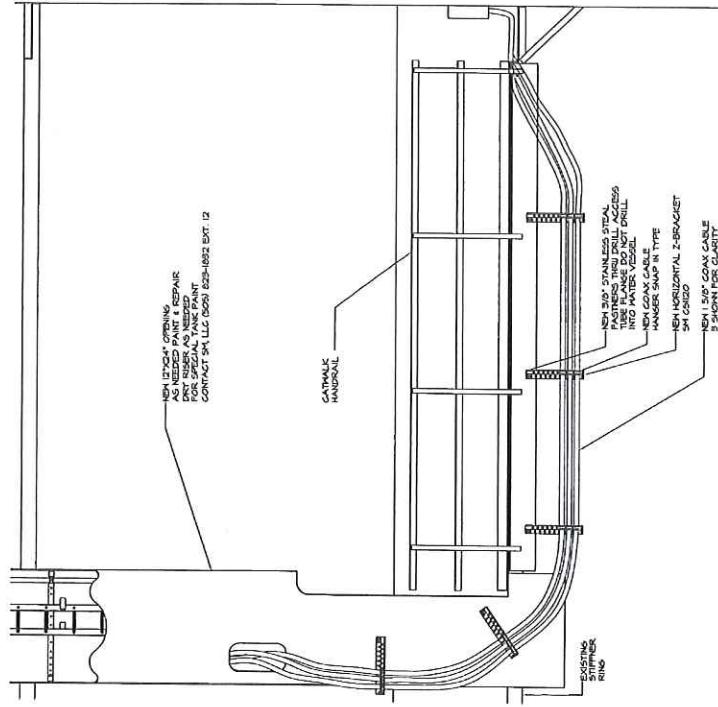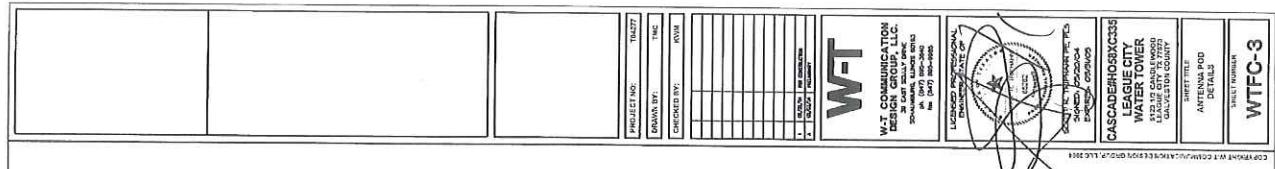


TANK NECK SECTION  
SCALE: NONE

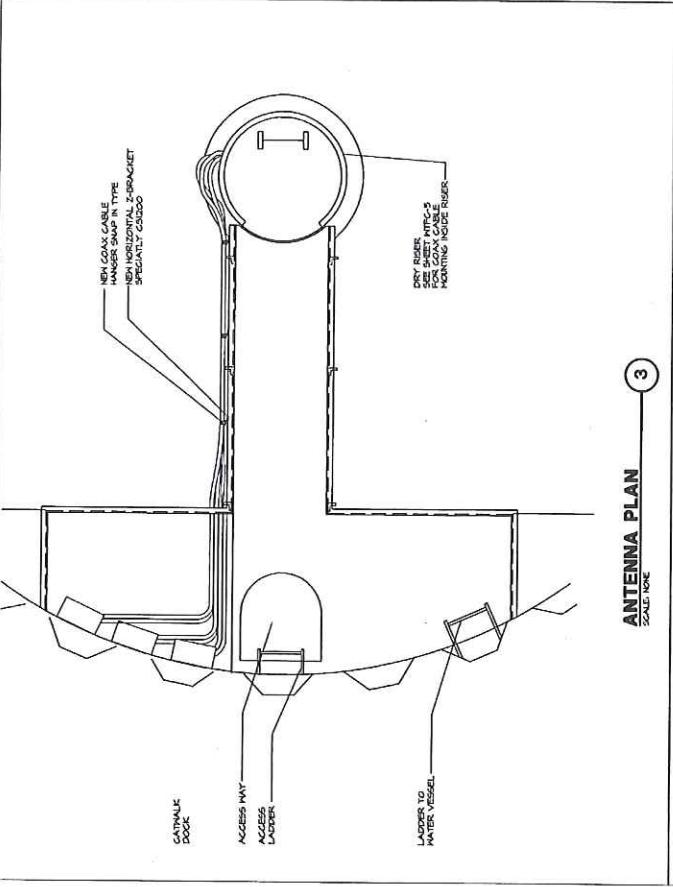


ANTENNA PLAN  
SCALE: NONE

NOT USED  
SCALE: NONE



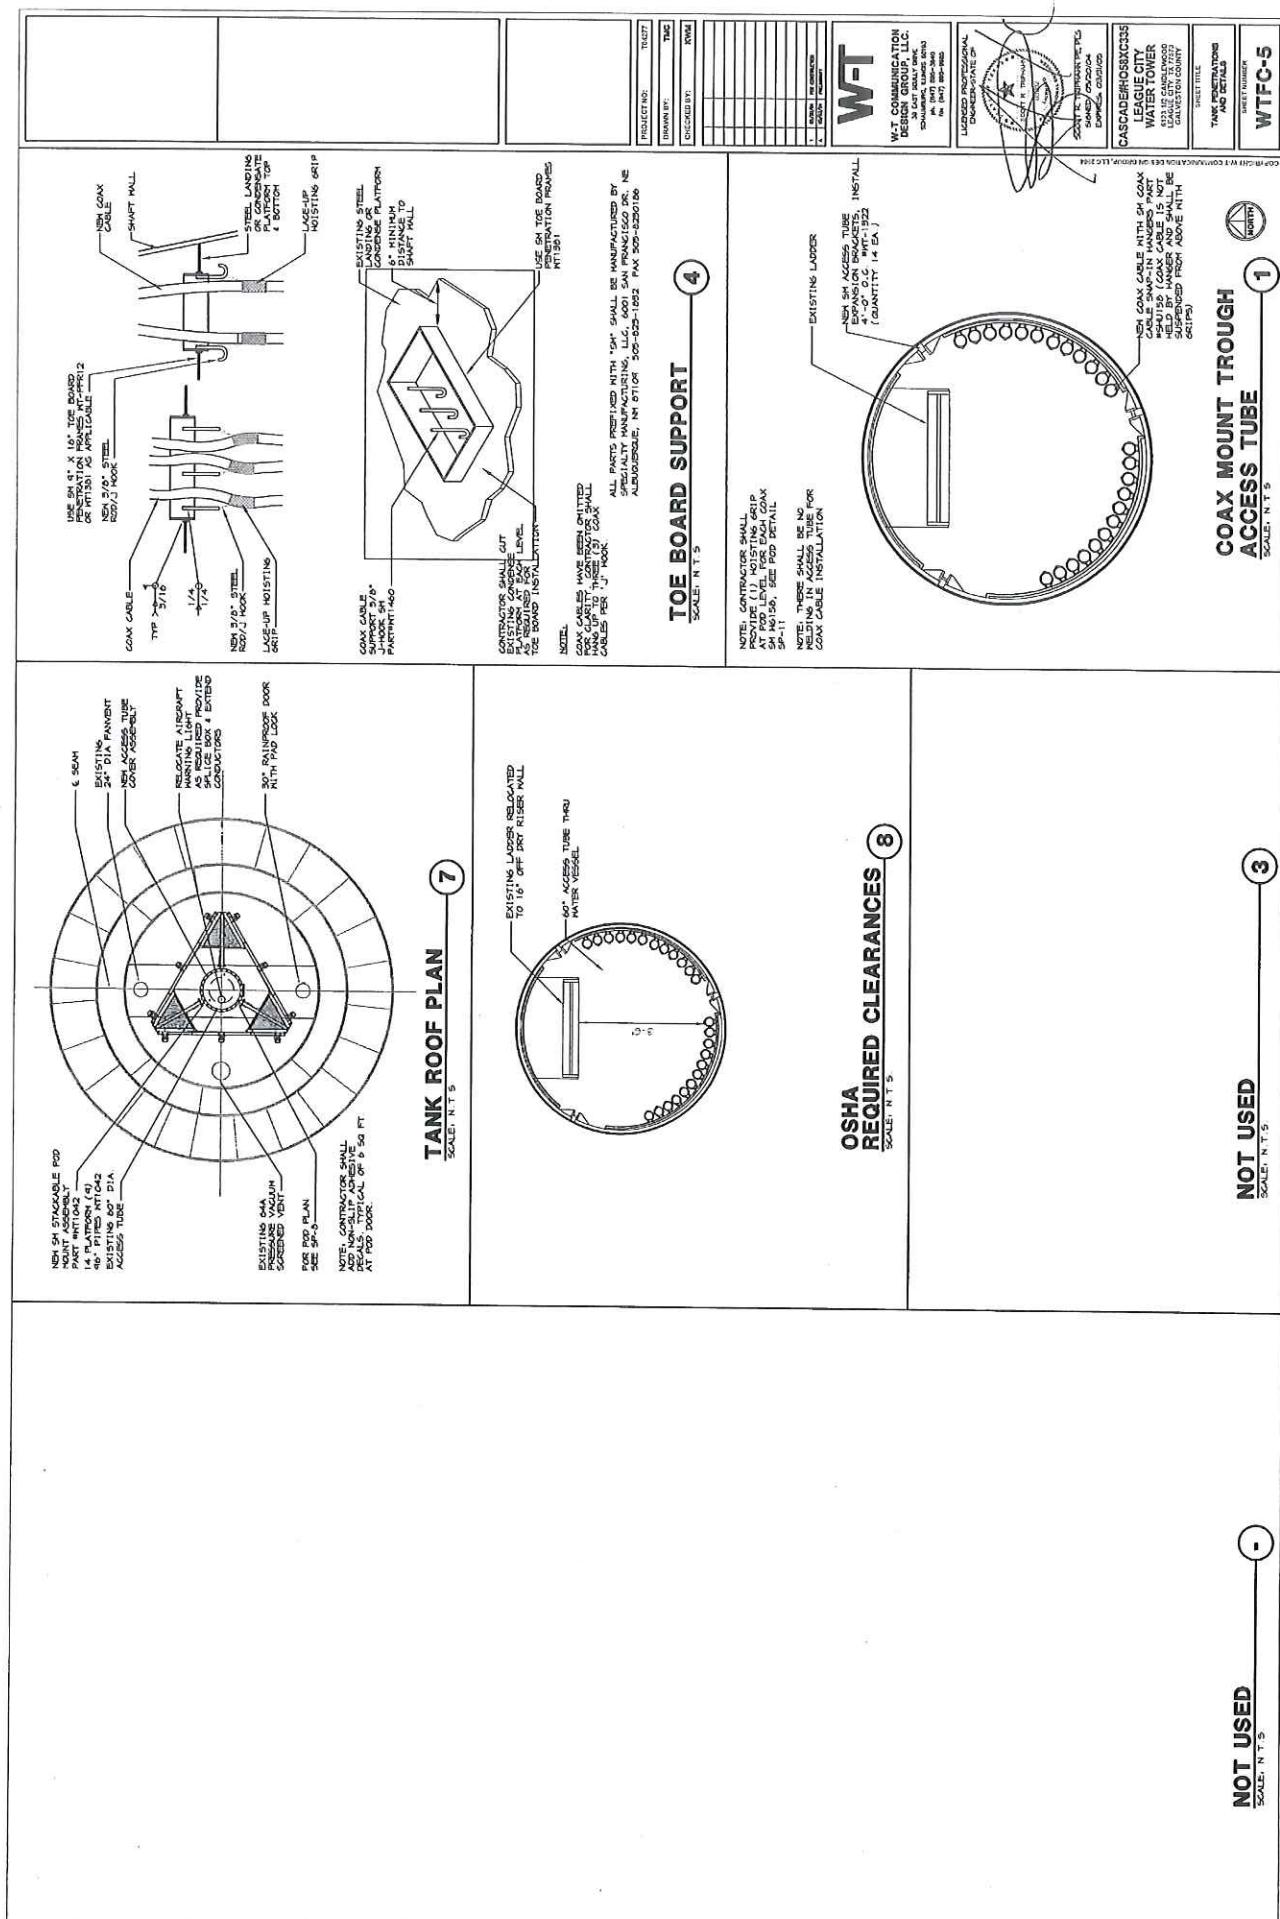





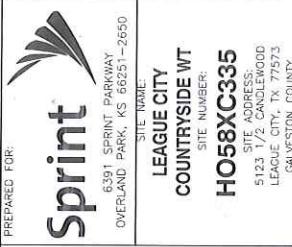

PREPARED FOR:

<b>ROLES &amp; RESPONSIBILITIES:</b>	
<b>Light Scope</b>	
<b>SPRINT:</b>	
- None	
<b>FIELD SERVICES:</b>	
	- Field Services to install FDP in existing Telco PPC
	- Field Services to remove old/legacy equipment from existing Telco PPC
	- Field Services to install +/- 10' of new fiber in existing X conduit from the existing Telco PPC to the existing MMBTS
<b>DARK FIBER VENDOR:</b>	
	- DFV to drop into the existing conduit on the pole. Proposed MMP to be utility pole at (29° 28'55.5" N 95°08'31.7" W)
	- DFV to install +/- (300') of new fiber in existing 3" conduit from proposed MMP to existing Telco PPC.
<b>CONDUIT OWNERSHIP NOTE:</b>	
	- Per Sprint direction, because existing conduit is running directly from Sprint equipment to CMMB and Sprint is currently using existing conduit, Sprint retains continued rights to use the existing conduit

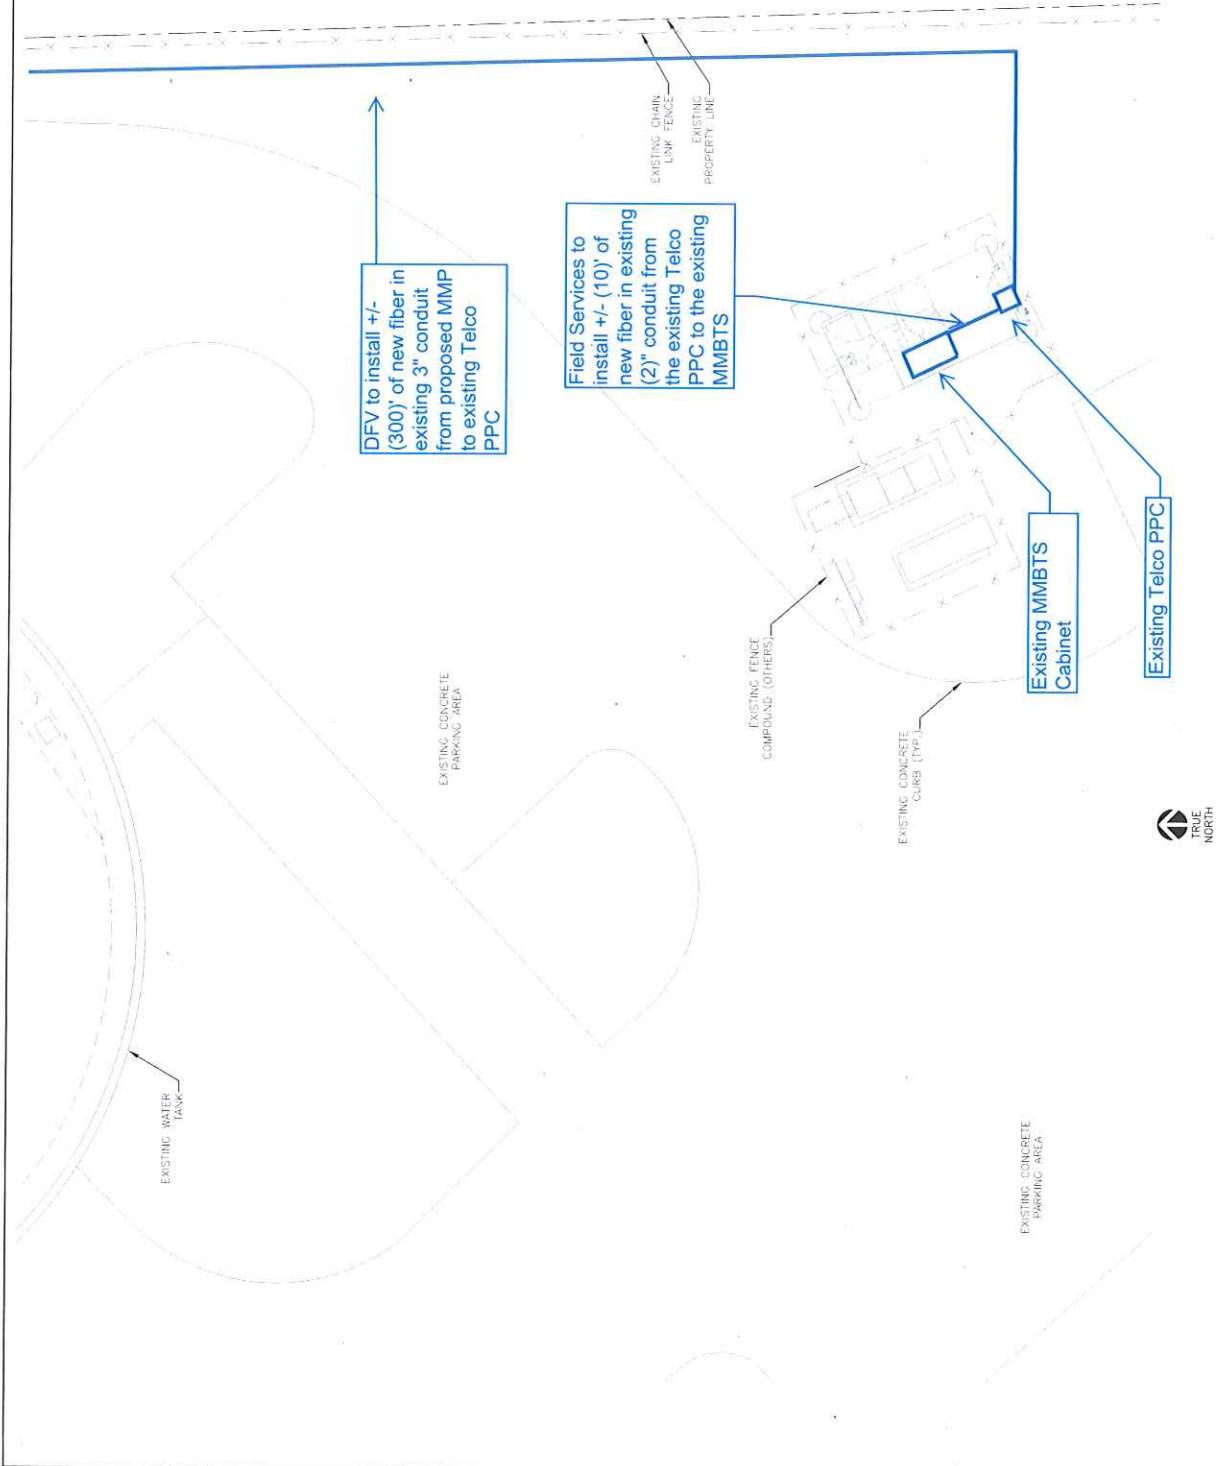

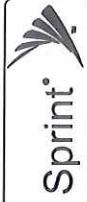

Proposed MMP	SCALE N.T.S.	1	Telco PPC	SCALE N.T.S.	2	MMBTS Cabinet	SCALE N.T.S.	3
						N/A		
H-Frame	SCALE N.T.S.	4						
MMP in Relation to Site	SCALE N.T.S.	7	Site Overview	SCALE N.T.S.	8	Conduit Path from Telco PPC to MMBTS	SCALE N.T.S.	9

**EXHIBIT "B"**

**MEMORANDUM OF AGREEMENT**

(SEE ATTACHED)

**RECORDING REQUESTED BY AND  
WHEN RECORDED MAIL TO:**  
Sprint Contracts & Performance  
Mailstop KSOPHT0101-Z2650  
6391 Sprint Parkway  
Overland Park, Kansas 66251-2650

[space above this line for Recorder's use]

### **MEMORANDUM OF LICENSE AGREEMENT**

THIS MEMORANDUM OF LICENSE AGREEMENT ("Memorandum"), by and between the City of League City, Texas, a Texas home-rule city ("Owner") and SprintCom, Inc., a Kansas corporation ("SprintCom"), evidences the License Agreement made and entered into between Owner and SprintCom dated \_\_\_\_\_ (the "Agreement").

The Agreement provides in part that Owner leases to SprintCom certain real property owned by Owner and located at 5123 1/2 Candlewood, City of League City, County of Galveston, State of Texas ("Property") for the purpose of installing, operating and maintaining a communications facility and other improvements. The Property is legally described in Exhibit A attached hereto. The portion of the Property leased to SprintCom together with non-exclusive utility and access easements (the "Site") is further described in the Agreement.

The new term of SprintCom's lease and tenancy under the Agreement is sixty (60) months, commencing on April 15, 2019, and is subject to two (2) renewal terms of sixty (60) months each that may be exercised by SprintCom.

IN WITNESS WHEREOF, the parties have executed this Amended Memorandum as of the day and year indicated below.

**Owner:**  
**City of League City, Texas, a Texas home-rule city**

By: \_\_\_\_\_  
**(please use blue ink)**  
Printed Name: \_\_\_\_\_  
Title: \_\_\_\_\_  
Date: \_\_\_\_\_

**SprintCom:**  
**SprintCom, Inc., a Kansas corporation**

By: \_\_\_\_\_  
Printed Name: Silvia J. Lin  
Title: Manager, Real Estate  
Date: \_\_\_\_\_

**OWNER NOTARY BLOCK: (please use blue ink)**

STATE OF \_\_\_\_\_

COUNTY OF \_\_\_\_\_

The foregoing instrument was (*choose one*)  attested or  acknowledged before me this \_\_\_\_\_  
day of \_\_\_\_\_, 201\_\_\_\_, by  \_\_\_\_\_, as  
\_\_\_\_\_ of the City of League City, Texas, a Texas home-rule city, on behalf of the  
city.

(AFFIX NOTARIAL SEAL)

\_\_\_\_\_  
(OFFICIAL NOTARY SIGNATURE)  
NOTARY PUBLIC STATE OF

My commission expires:

\_\_\_\_\_  
(PRINTED, TYPED OR STAMPED NAME OF  
NOTARY)  
COMMISSION NUMBER:

**SPRINTCOM NOTARY BLOCK:**

STATE OF KANSAS )  
COUNTY OF JOHNSON ) ss.  
                      )

Acknowledgment by Corporation  
Pursuant to Uniform Acknowledgment Act

The foregoing instrument was acknowledged before me this \_\_\_\_\_ day of \_\_\_\_\_, 201\_\_\_\_, by \_\_\_\_\_  
on behalf of SprintCom, Inc., a Kansas corporation.

(AFFIX NOTARIAL SEAL)

\_\_\_\_\_  
(OFFICIAL NOTARY SIGNATURE)  
NOTARY PUBLIC STATE OF

My commission expires:

\_\_\_\_\_  
(PRINTED, TYPED OR STAMPED NAME OF  
NOTARY)

**EXHIBIT A**  
**TO MEMORANDUM OF LICENSE AGREEMENT**

A parcel of land for the PCS within that certain 1.3501 acre tract of land known as Tract "A", or the "Elevated Storage Tank Site", owned by the City of League City, Texas and acquired through Eminent Domain Proceeding, in Galveston County, Texas;

Also known as a Abstract 9, Page 7 & 8, a portion of Lot 12 (12-1) Jensen Colony Subdivision, which has an address of 5123 1/2 Candlewood, League City, Texas.